
## YORK COUNTY PLANNING DEPARTMENT RENOVATION

100% CONSTRUCTION DOCUMENTS

18 LIBERTY STREET, YORK, SC

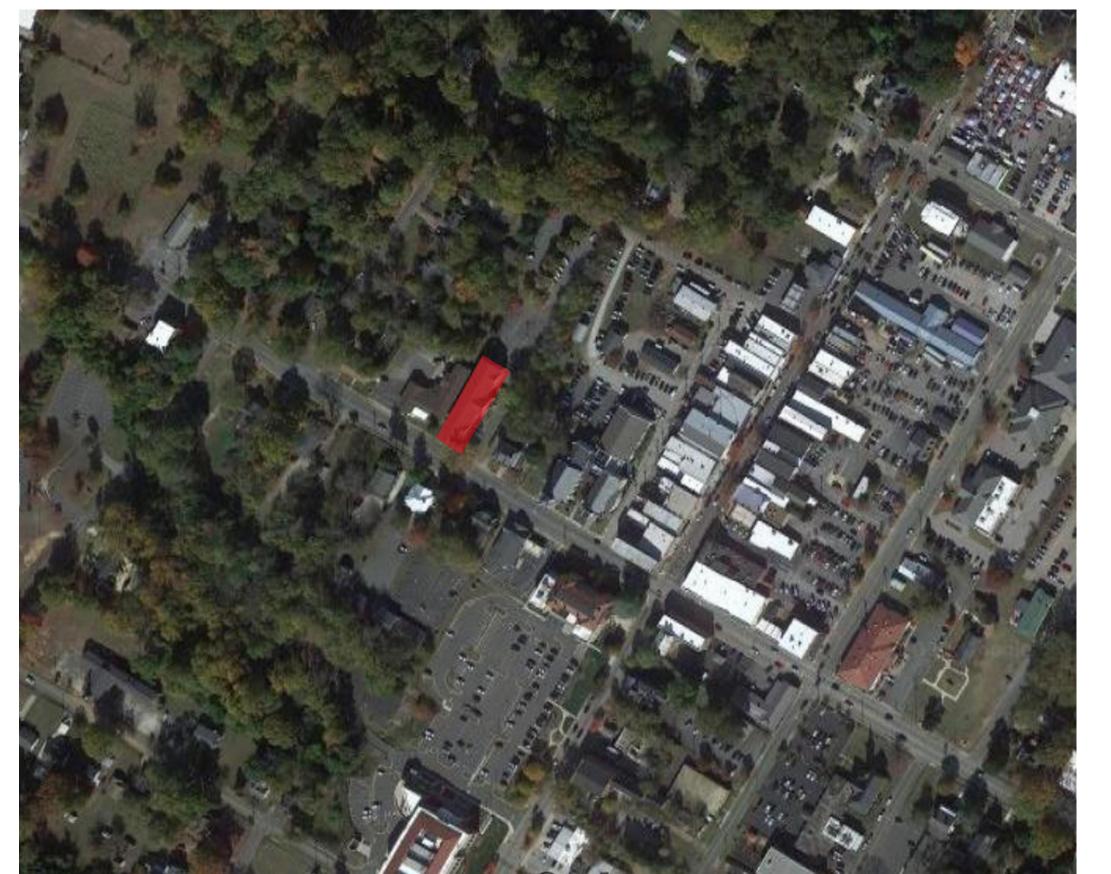

A	
AFF	ABOVE FINISHED FLOOR
AP	ACCESS PANEL
ACOUS	ACOUSTICAL
<b>ACT</b>	ACOUSTICAL CEILING TILE
AWP	ACOUSTICAL WALL PANEL
ADJ	ADJACENT
A/C	AIR CONDITIONING
ALT	ALTERNATE
ALUM	ALUMINUM
AB	ANCHOR BOLT
ANOD	ANODIZED
APPROX	APPROXIMATE
ARCH	ARCHITECT, ARCHITECTURAL
AD	AREA DRAIN
ACM	ASBESTOS CONTAINING MATERIAL
<u> </u>	AT
AUTO	AUTOMATIC
В	
 ВР	BEARING PLATE
вм Вм	BENCH MARK
BITUM	BITUMINOUS
BLK	BLOCK
BLKG	BLOCKING
BD.	BOARD
вот	BOTTOM
BRK	BRICK
BLDG	BUILDING
BN	BULLNOSE
C	BOLLINOSE
CAB	CABINET
CI CI	CAST IRON
	CATCH BASIN OR CHALK BOARD
CB CLC	
CLG LIT	CEILING HEICHT
CLG HT CL	CEILING HEIGHT CENTER LINE
CER	CERAMIC
CIRC	CIRCUMFERENCE
CO	CLEAN OUT
CLR	CLEAR
COL	COLUMN
CONC	CONCRETE
CMU	CONCRETE MASONRY UNIT
CONST	CONSTRUCTION
CJT	CONSTRUCTION JOINT
CONT	CONTINUOUS
CONTR	CONTRACTOR
CJ	CONTROL JOINT

DP	DAMP PROOFING
DEMO	DEMOLISH
DEPT	DEPARTMENT
DET,DTL	DETAIL
DIA	DIAMETER
DIM	DIMENSION
DISP	DISPENSER
DSP	DISPOSAL
DO	DITTO, REPEAT, SAME
DR DR	DOOR DOOR
DBL	DOUBLE
DN	DOWN
DS DT	DOWNSPOUT
DI	DRAIN TILE
DWR	DRAWER
DWG	DRAWING
DF	DRINKING FOUNTAIN
E .	
EA	EACH
EF	EACH FACE
EW	EACH WAY
E	EAST
ELEC	ELECTRICAL
ELEV	ELEVATION
EL	ELEVATOR
EMER	EMERGENCY
ENCL	ENCLOSURE
ENTR	ENTRANCE
EQ	EQUAL
EQUIP	EQUIPMENT
EST	ESTIMATE(D)
EXHST	EXHAUST
EXIST	EXISTING
EXP	EXPANSION
EJ	EXPANSION JOINT
F	
FAB	FABRICATE
FT	FEET
FIG	FIGURE
FIN	FINISH
FF	FINISH FLOOR
FEC	FIRE EXTINGUISHER CABINET
FH	FIRE HOSE
FL,FLR	FLOOR
FD	FLOOR DRAIN
FTG	FOOTING
FND	FOUNDATION
יויט	I COLLECTION

FULL SIZE	LDR	LEADER
FUTURE	LH	LEFT HAND
	LIB	LIBRARY
GALVANIZED	LT	LIGHT
GAS	LW	LIGHT WEIGHT
GAUGE	М	,
GENERAL	MACH	MACHINE
GENERAL CONTRACTOR	MH	MAN HOLE
GLASS, GLAZING	мнс	MAN HOLE COVER
GRAB BAR	MFR	MANUFACTURE
GRADE, GRADING	MFRR	MANUFACTURER
GROSS SQUARE FOOT	MAS	MASONRY
GYPSUM	МО	MASONRY OPENING
GYPSUM BD	MAT	MATERIALS
GYPSUM WALL BOARD	MAX	MAXIMUM
	MECH	MECHANICAL
HARDWARE	MET	METAL
HARDWOOD	MTL	METAL
HEATING, VENTILATING & AIR	М	METER
CONDITIONING	MEZZ	MEZZANINE
HEIGHT	MIN	MINIMUM
HEXAGONAL	MISC	MISCELLANEOUS
HIGHWAY	MR	MOISTURE RESISTANT
HOLLOW METAL	MTD	MOUNTED
HORIZONTAL	N	
HOSE BIBB	NAT	NATURAL
HOT WATER	NRC	NOISE REDUCTION COEFFICIENT
HOUR	NOM	NOMINAL
	N	NORTH
INCH	NIC	NOT IN CONTRACT
INCLUDING	NTS	NOT TO SCALE
INSIDE DIAMETER	NO, #	NUMBER
INSULATION	0	
INTERIOR	ОС	ON CENTER
INTERMEDIATE	OPNG	OPENING
INVERT	OD	OUTSIDE DIAMETER
	ОН	OVERHEAD
JANITOR	Р	
JANITOR SINK	PT	PAINT(ED)
JOINT	PR	PAIR
	PTR	PAPER TOWEL RECEPTOR
KITCHEN	PKG	PARKING
	PART BD	PARTICLE BOARD
LABEL	PART	PARTITION
LABORATORY	PVMT	PAVEMENT
LAMINATE(D)	PL	PLATE
LAVATORY	PLBG	PLUMBING
LAYER	PLYWD	PLYWOOD
		· · · · · · · · · · · · · · · · · · ·

		CONC	PRECASI CONCRETE
	PR	E FAB	PREFABRICATED
	PT		PRESSURE TREATED
	PL		PROPERTY LINE
	Q		
	Qī	Υ	QUANTITY
	R		
	R.A	۱D	RADIUS
	RE	СР	RECEPTACLE
	RE	:	REFER TO
	RE		REFERENCE
<del></del>	l —	FR	REFRIGERATOR
<u> </u>	l —	INF	REINFORCED(ING)
	l ⊢	Q'D	REQUIRED
	RE		REVISED
	RH		RIGHT HAND
	R	•	RISER
	RC	)	ROOF DRAIN
	RA		ROOM
	RC		ROUGH OPENING
	S	,	ROUGH OF LIVING
г	SA	NI	C A NII A DV
<u> </u>	l	CHED	SANITARY
	SE		SCHEDULE SECOND
COEFFICIENT		CT	SECTION
COEFFICIENT	SIA		SIMILAR
	SS		SOLID SURFACE MATERIAL
	STO	<b>-</b>	SOUND TRANSMISSION COEFFICIENT
	SP	EC	SPECIFICATION
	SG	)	SQUARE
	SS		STAINLESS STEEL
	STI	)	STANDARD
	STI	-	STEEL
	STO	OR	STORAGE
	SC	FT	STRUCTURAL GLAZED FACING TILE
	ST	STL	STRUCTURAL STEEL
	STF	RUCT	STRUCTURE, STRUCTURAL
	SU	SP	SUSPENDED
PTOR	SA	.T	SUSPENDED ACOUSTICAL TILE
-	T		
	TEI	L	TELEPHONE
	TE	MP	TEMPERATURE
	TH	K	THICKNESS
	TPI		TOILET PAPER DISPENSER
	TC		TOP OF SLAB/STEEL
		)W	TOP OF WALL

ГҮР	TYPICAL
J	
UNFIN	UNFINISHED
UNO	UNLESS NOTED OTHERWISE
U	URINAL
V	<u> </u>
VEN	VENEER
VIF	VERIFY IN FIELD
VEST	VESTIBULE
VOL	VOLUME
W	
WC	WATER CLOSET
WT	WEIGHT
WWF	WELDED WIRE FABRIC
WWM	WELDED WIRE MESH
W	WEST
WIND	WINDOW
W/	WITH
W/O	WITHOUT
WD	WOOD
Y	·
YD	YARD

GENERAL				
G000	COVER			
CIVIL				
C001	COVER SHEET			
C100	EXISTING CONDITIONS AND DEMOLITION PLAN			
C200	SITE AND GRADING PLAN			
C300 SITE CIVIL DETAILS				
	AL FLOOR PLAN AND ENLARGED FLOOR PLANS			
A200				
A200 A300	FLOOR PLAN AND ENLARGED FLOOR PLANS			
ARCHITECTUM A200 A300 PLUMBING P101	FLOOR PLAN AND ENLARGED FLOOR PLANS			
A200 A300 PLUMBING	FLOOR PLAN AND ENLARGED FLOOR PLANS BUILDING ELEVATIONS			



**ARCHITECT** 

CPL | Architecture Engineering Planning 6302 Fairview Road T. 704.331.9131 CPLteam.com



PROJECT INFORMATION

R23.00292.00 YORK COUNTY

**RENOVATION** 

PLANNING DEPARTMENT

Project Address 18 LIBERTY STREET, YORK, SC





SHEET INFORMATION 04/16/2024 Project Status 100% CONSTRUCTION DOCUMENTS Drawn By


Drawing Title COVER

Drawing Number


# YORK COUNTY PLANNING DEPARTMENT RENOVATION

100% CONSTRUCTION DOCUMENTS

APRIL 2024

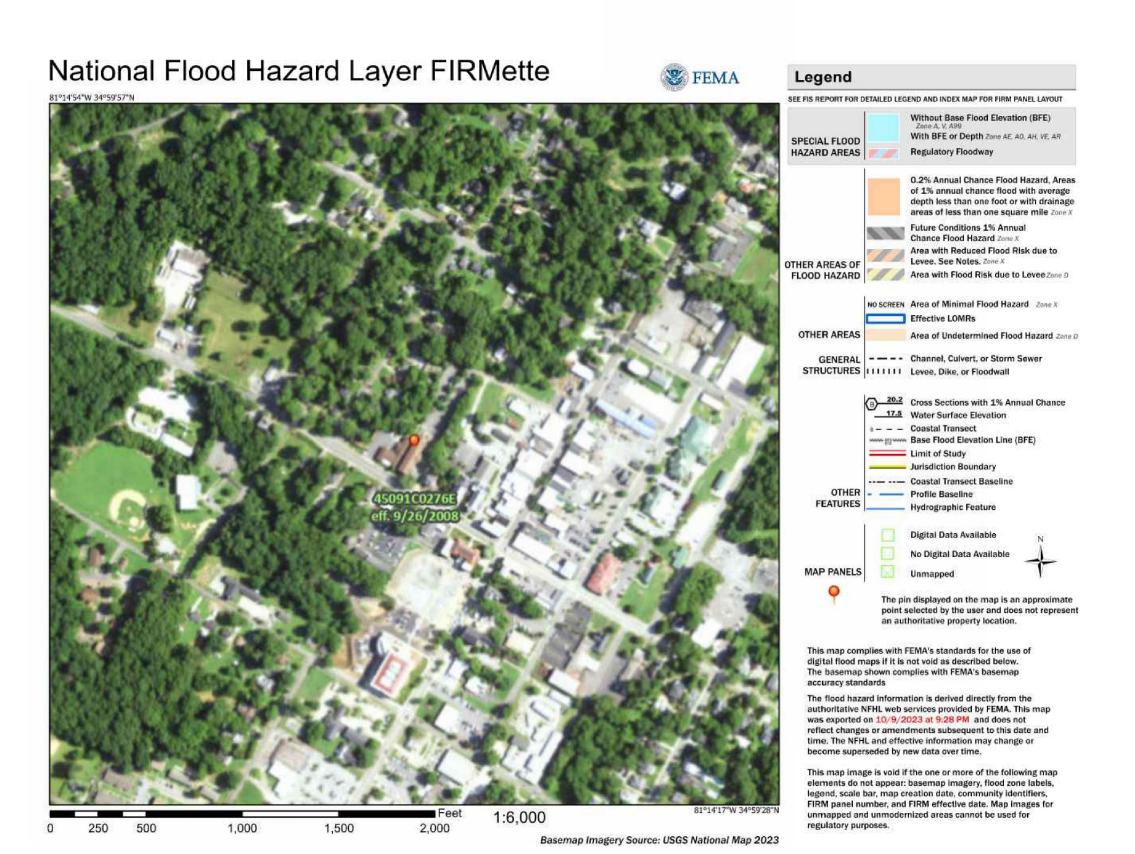

### CITY OF YORK YORK COUNTY, SC

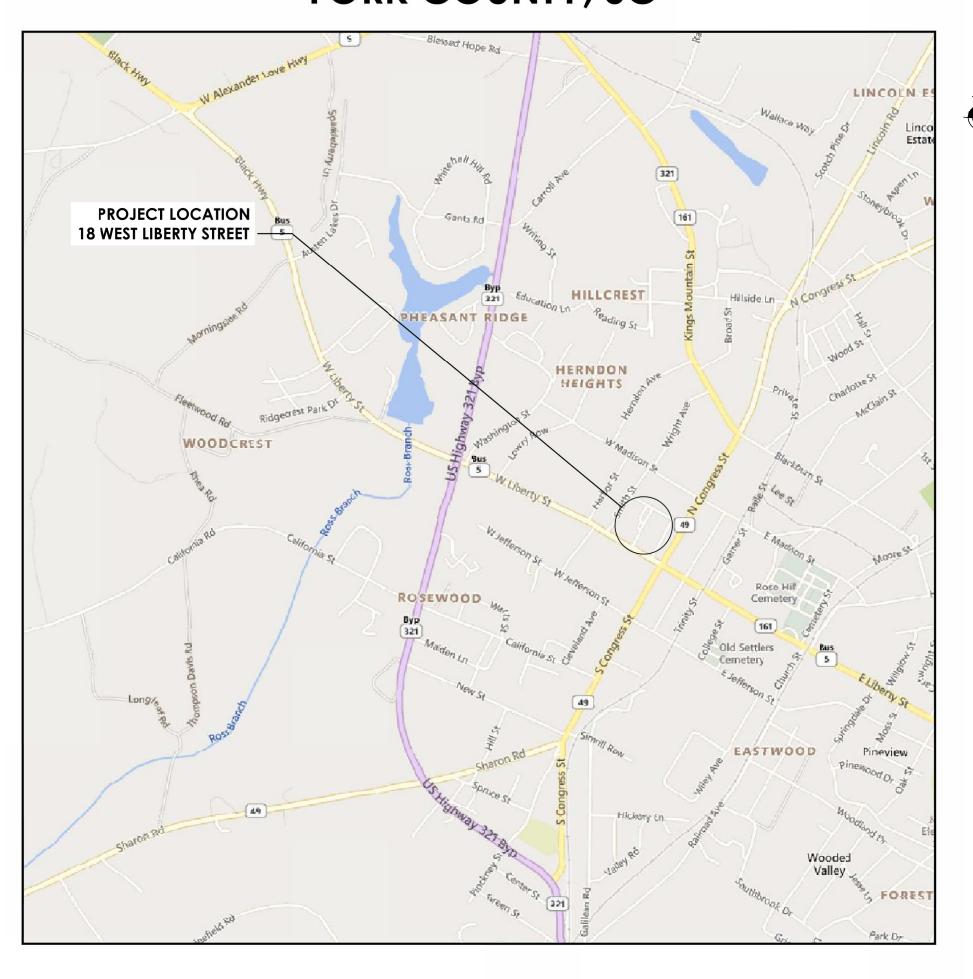

LOCATION PLAN



DRAWING INDEX					
DWG. NO.	SHEET TITLE				
C001	COVER SHEET				
C100	EXISTING CONDITIONS AND DEMOLITION PLAN				
C200	SITE AND GRADING PLAN				
C300	SITE CIVIL DETAILS				

SITE STATISTICS					
PIN	0700301025				
CITY	YORK				
COUNTY	YORK				
ZONING DISTRICT	CENTRAL BUISINESS (B-1)				
TOTAL ACREAGE	0.776 AC				
EXISTING LAND USE	821 - GOVERNMENT				
PROPOSED LAND USE	821 - GOVERNMENT				
PROPOSED BUILDING SQUARE FOOTAGE	0 SF				
PROPOSED BUILDING HEIGHT	0 FT				
PROPOSED NUMBER OF STORIES	N/A				
WATER SUPPLY WATERSHED PROTECTION OVERLAY DISTRICT	N/A				
SPECIAL FLOOD HAZARD AREA	N/A				


#### **OWNER INFORMATION:**

YORK COUNTY
CONTACT:
ADDRESS: 10 N. ROSEVELT ST.
PO BOX 500
YORK, SC 29745
PHONE: 803.684.2341

#### **DESIGN PROFESSIONAL:**

CPL
CONTACT: RICH EDINGER, P.E.
ADDRESS: 3011 SUTTON GATE DRIVE, SUITE 130
SUWANEE, GA 30024
PHONE: 770.831.9000



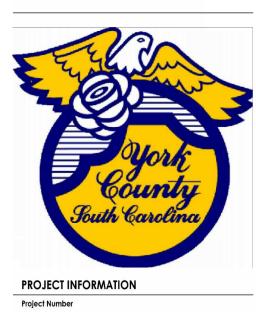

Project Number
R23.00292.00
Client Name
YORK COUNTY

**RENOVATION** 

Project Name

Project Address
18 LIBERTY STREET, YORK, SC

PROJECT ISSUE & REVISION SCHEDULE

PROFESSIONAL STAMPS





SHEET INFORMATION


Issued Scale
4/16/2024 AS NOTED

Project Status
100% CONSTRUCTION DOCUMENTS
Drawn By Checked By
CPL CPL

Drawing Title

COVER SHEET

YCO

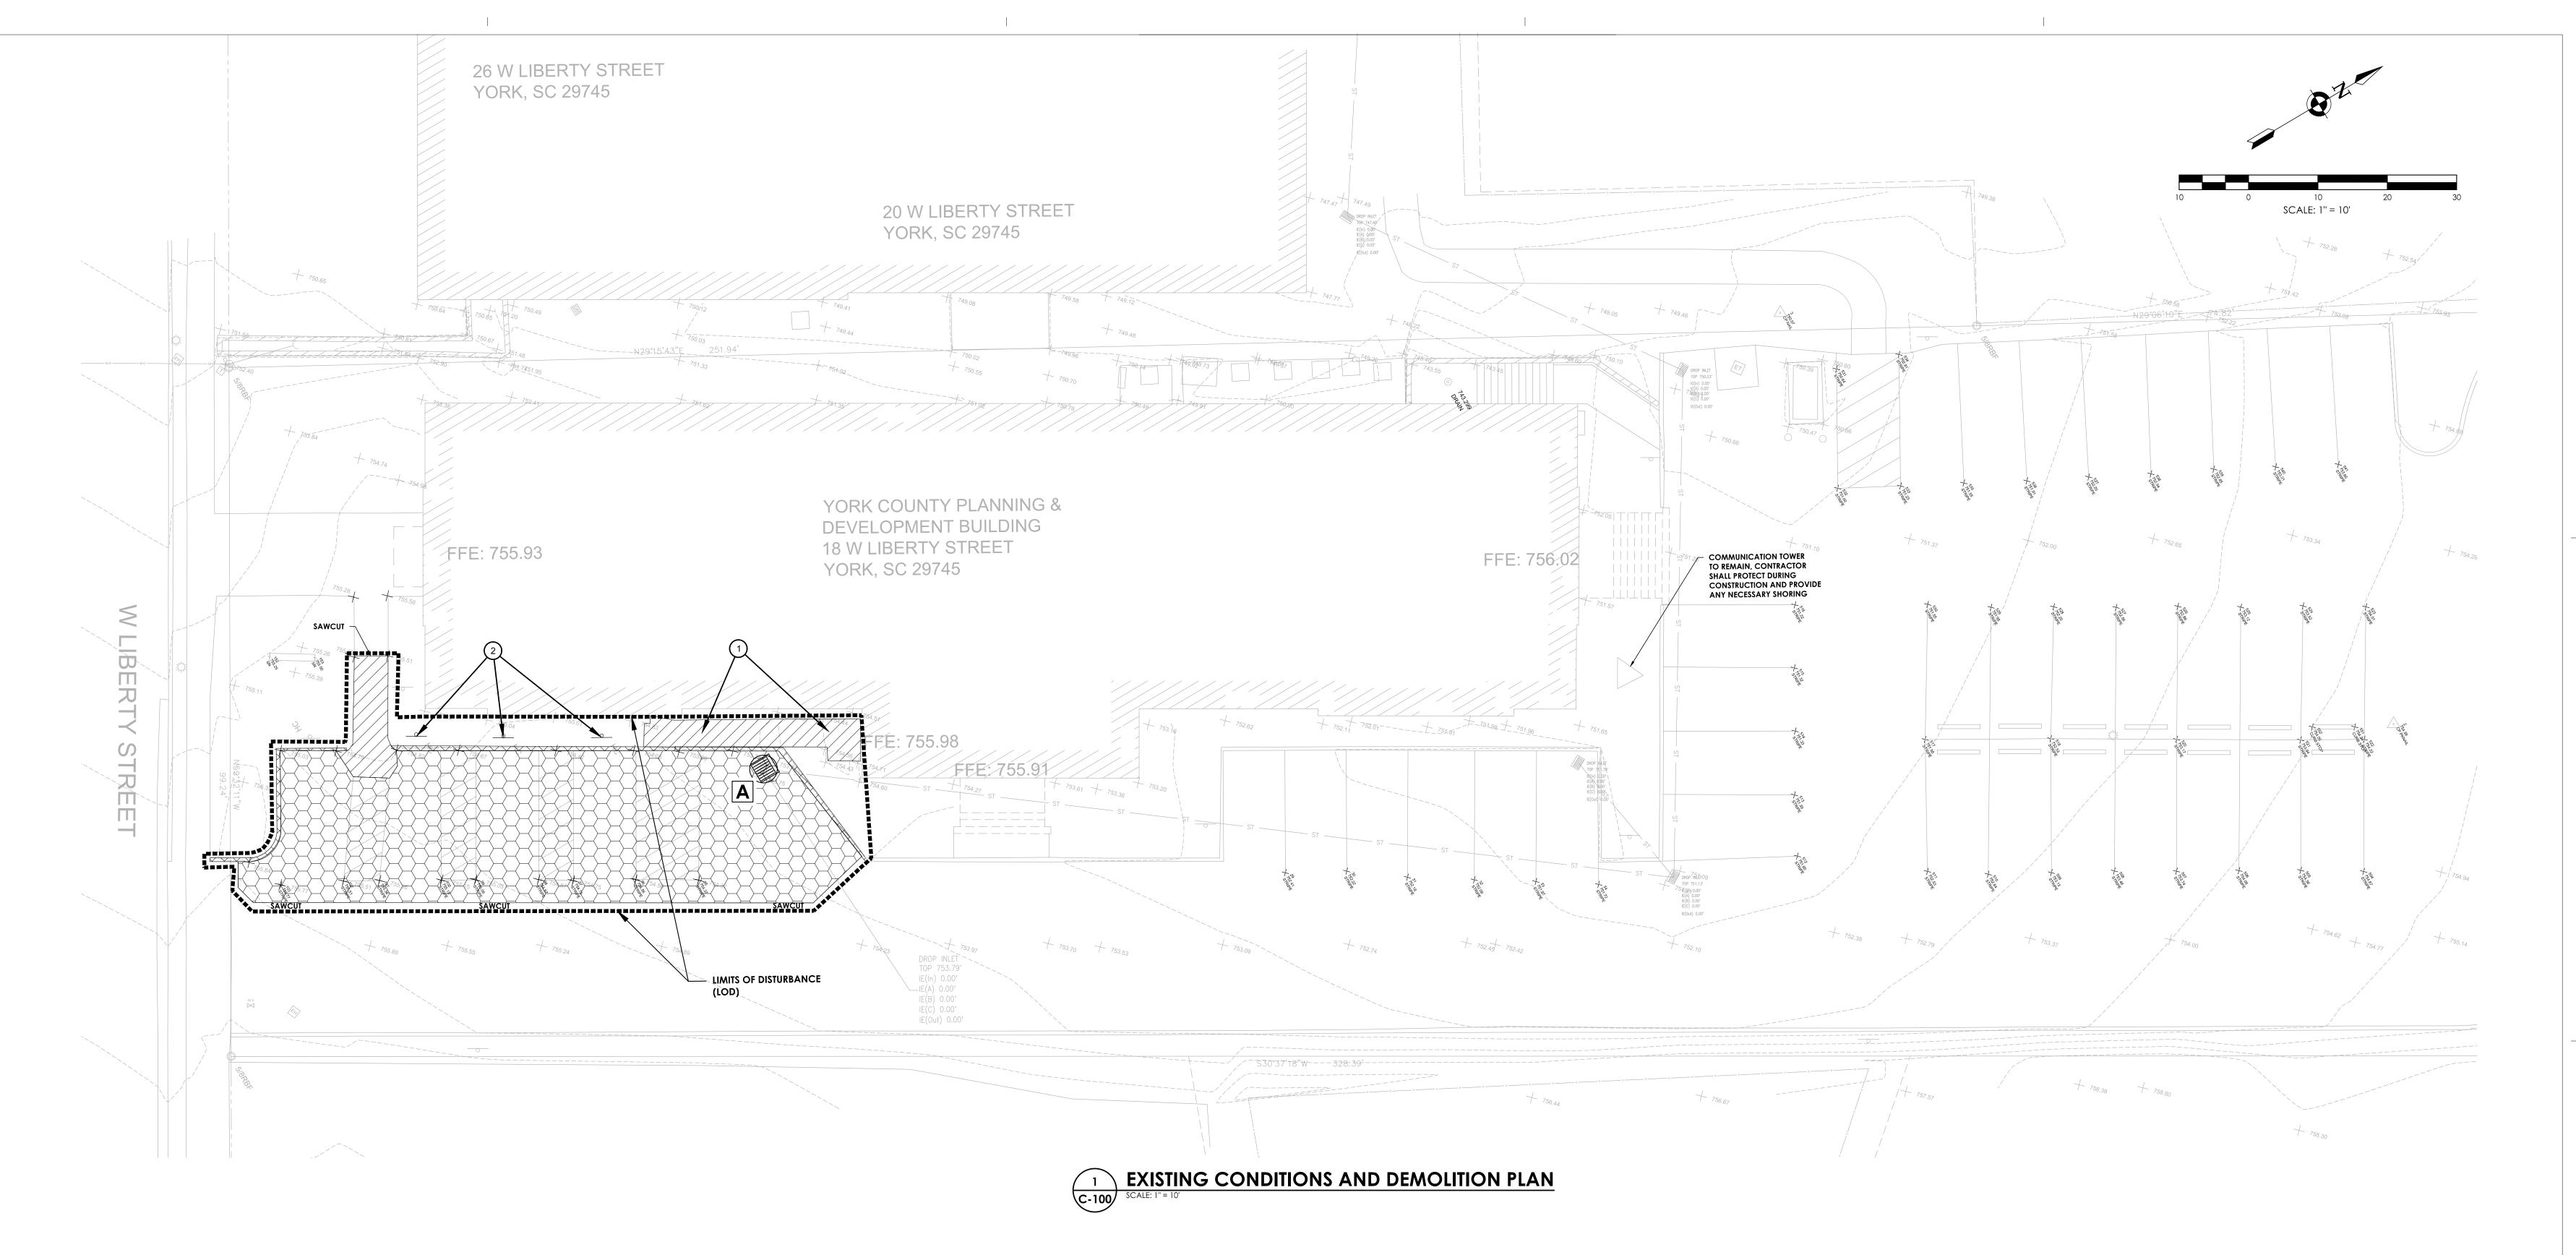

325 W. McBee Avenue, Suite 300 Greenville, SC 29601



Project Number R23.00292.00

YORK COUNTY

Project Name

PLANNING DEPARTMENT **RENOVATION** 

Project Address 18 LIBERTY STREET, YORK, SC

PROJECT ISSUE & REVISION SCHEDULE

No. Date Description

PROFESSIONAL STAMPS






2024.04.20 10:31:20-04'00'

4/16/2024 1" = 20' Project Status 100% CONSTRUCTION DOCUMENTS Drawn By Checked By CPL CPL Drawing Title EXISTING CONDITIONS AND DEMOLITION PLAN

SHEET INFORMATION

#### **LEGEND**

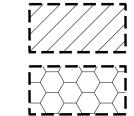

SAWCUT, DEMOLISH, REMOVE AND LEGALLY DISPOSE OF CONCRETE PAVEMENT






DEMOLISH, REMOVE AND LEGALLY DISPOSE OF CONCRETE CURB



TYPE A FILTER FABRIC INLET PROTECTION

RELOCATED AS SHOWN ON SHEET C-200

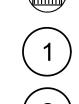



REMOVE EXISTING HANDICAP SIGNS/POSTS, SIGNS TO BE

DEMOLISH AND REMOVE HC RAMP AND RAILING

#### **DEMOLITION NOTES:**

- 1. CONTRACTOR SHALL CONDUCT DEMOLITION ACTIVITIES WITHOUT INTERFERING WITH VEHICLE AND PEDESTRIAN
- 2. CONTRACTOR SHALL PROTECT UTILITIES AND BENCHMARKS NOT SCHEDULED FOR DEMOLITION FROM DAMAGE. AT NO ADDITIONAL COST TO OWNER, THE CONTRACTOR SHALL REPLACE OR REPAIR ITEMS DAMAGED BEYOND THE
- 3. DISCONNECT AND SEAL OFF ABANDONED UTILITIES TO BE REMOVED PRIOR TO THE START OF ANY DEMOLITION ACTIVITIES. UTILITIES SHALL BE DISCONNECTED BELOW EXISTING GRADE LEVEL, OR OUTSIDE OF CONTRACT LIMITS BY REPRESENTATIVES OF THE PUBLIC UTILITY BEING DISCONNECTED. MAINTAIN UTILITY SERVICE TO FACILITIES IN USE. 4. EXCEPT FOR ITEMS DESIGNATED TO BE REMOVED OR REUSED IN THE WORK, ALL MATERIALS RESULTING FROM THIS WORK SHALL BECOME THE PROPERTY OF THE CONTRACTOR, AND SHALL BE PROMPTLY REMOVED FROM THE SITE.
- STORAGE OR SALE OF REMOVED MATERIALS WILL NOT BE PERMITTED ON PROJECT SITE. REMOVE ALL DEBRIS, RUBBISH, AND WASTE MATERIALS FROM THE SITE. DO NOT STOCKPILE DEBRIS ON SITE. 6. ALL MATERIALS SHALL BE DISPOSED OF IN A LEGAL MANNER.
- 7. ALL LAND DISTURBANCE TO BE STABILIZED WITH VEGETATION UPON COMPLETION OF DEMOLITION PER THE EROSION
- 8. ALL TREES TO REMAIN SHALL HAVE PROPER PROTECTION UNLESS APPROVED PLANS INDICATES OTHERWISE. 9. DUMPSTERS AND/OR TEMPORARY SANITARY FACILITIES SHALL NOT BE LOCATED IN THE STREET AND TREE PROTECTION
- 10. SAWCUT PAVEMENTS, CURBS, AND/OR WALLS WHOLE TO PROVIDE SMOOTH TRANSITION BETWEEN IMPROVEMENTS TO REMAIN & NEW IMPROVEMENTS.
- 11. CONTRACTOR IS RESPONSIBLE FOR ALL MAINTENANCE OF TRAFFIC AND MUST SUBMIT A MAINTENANCE OF TRAFFIC
- 12. CONTRACTOR IS RESPONSIBLE FOR PROVIDING TEMPORARY BARRIER, METHOD 2 (PER GDOT.) PROVIDE LOCATIONS OF TEMPORARY BARRIERS ON THE MAINTENANCE OF TRAFFIC PLAN.

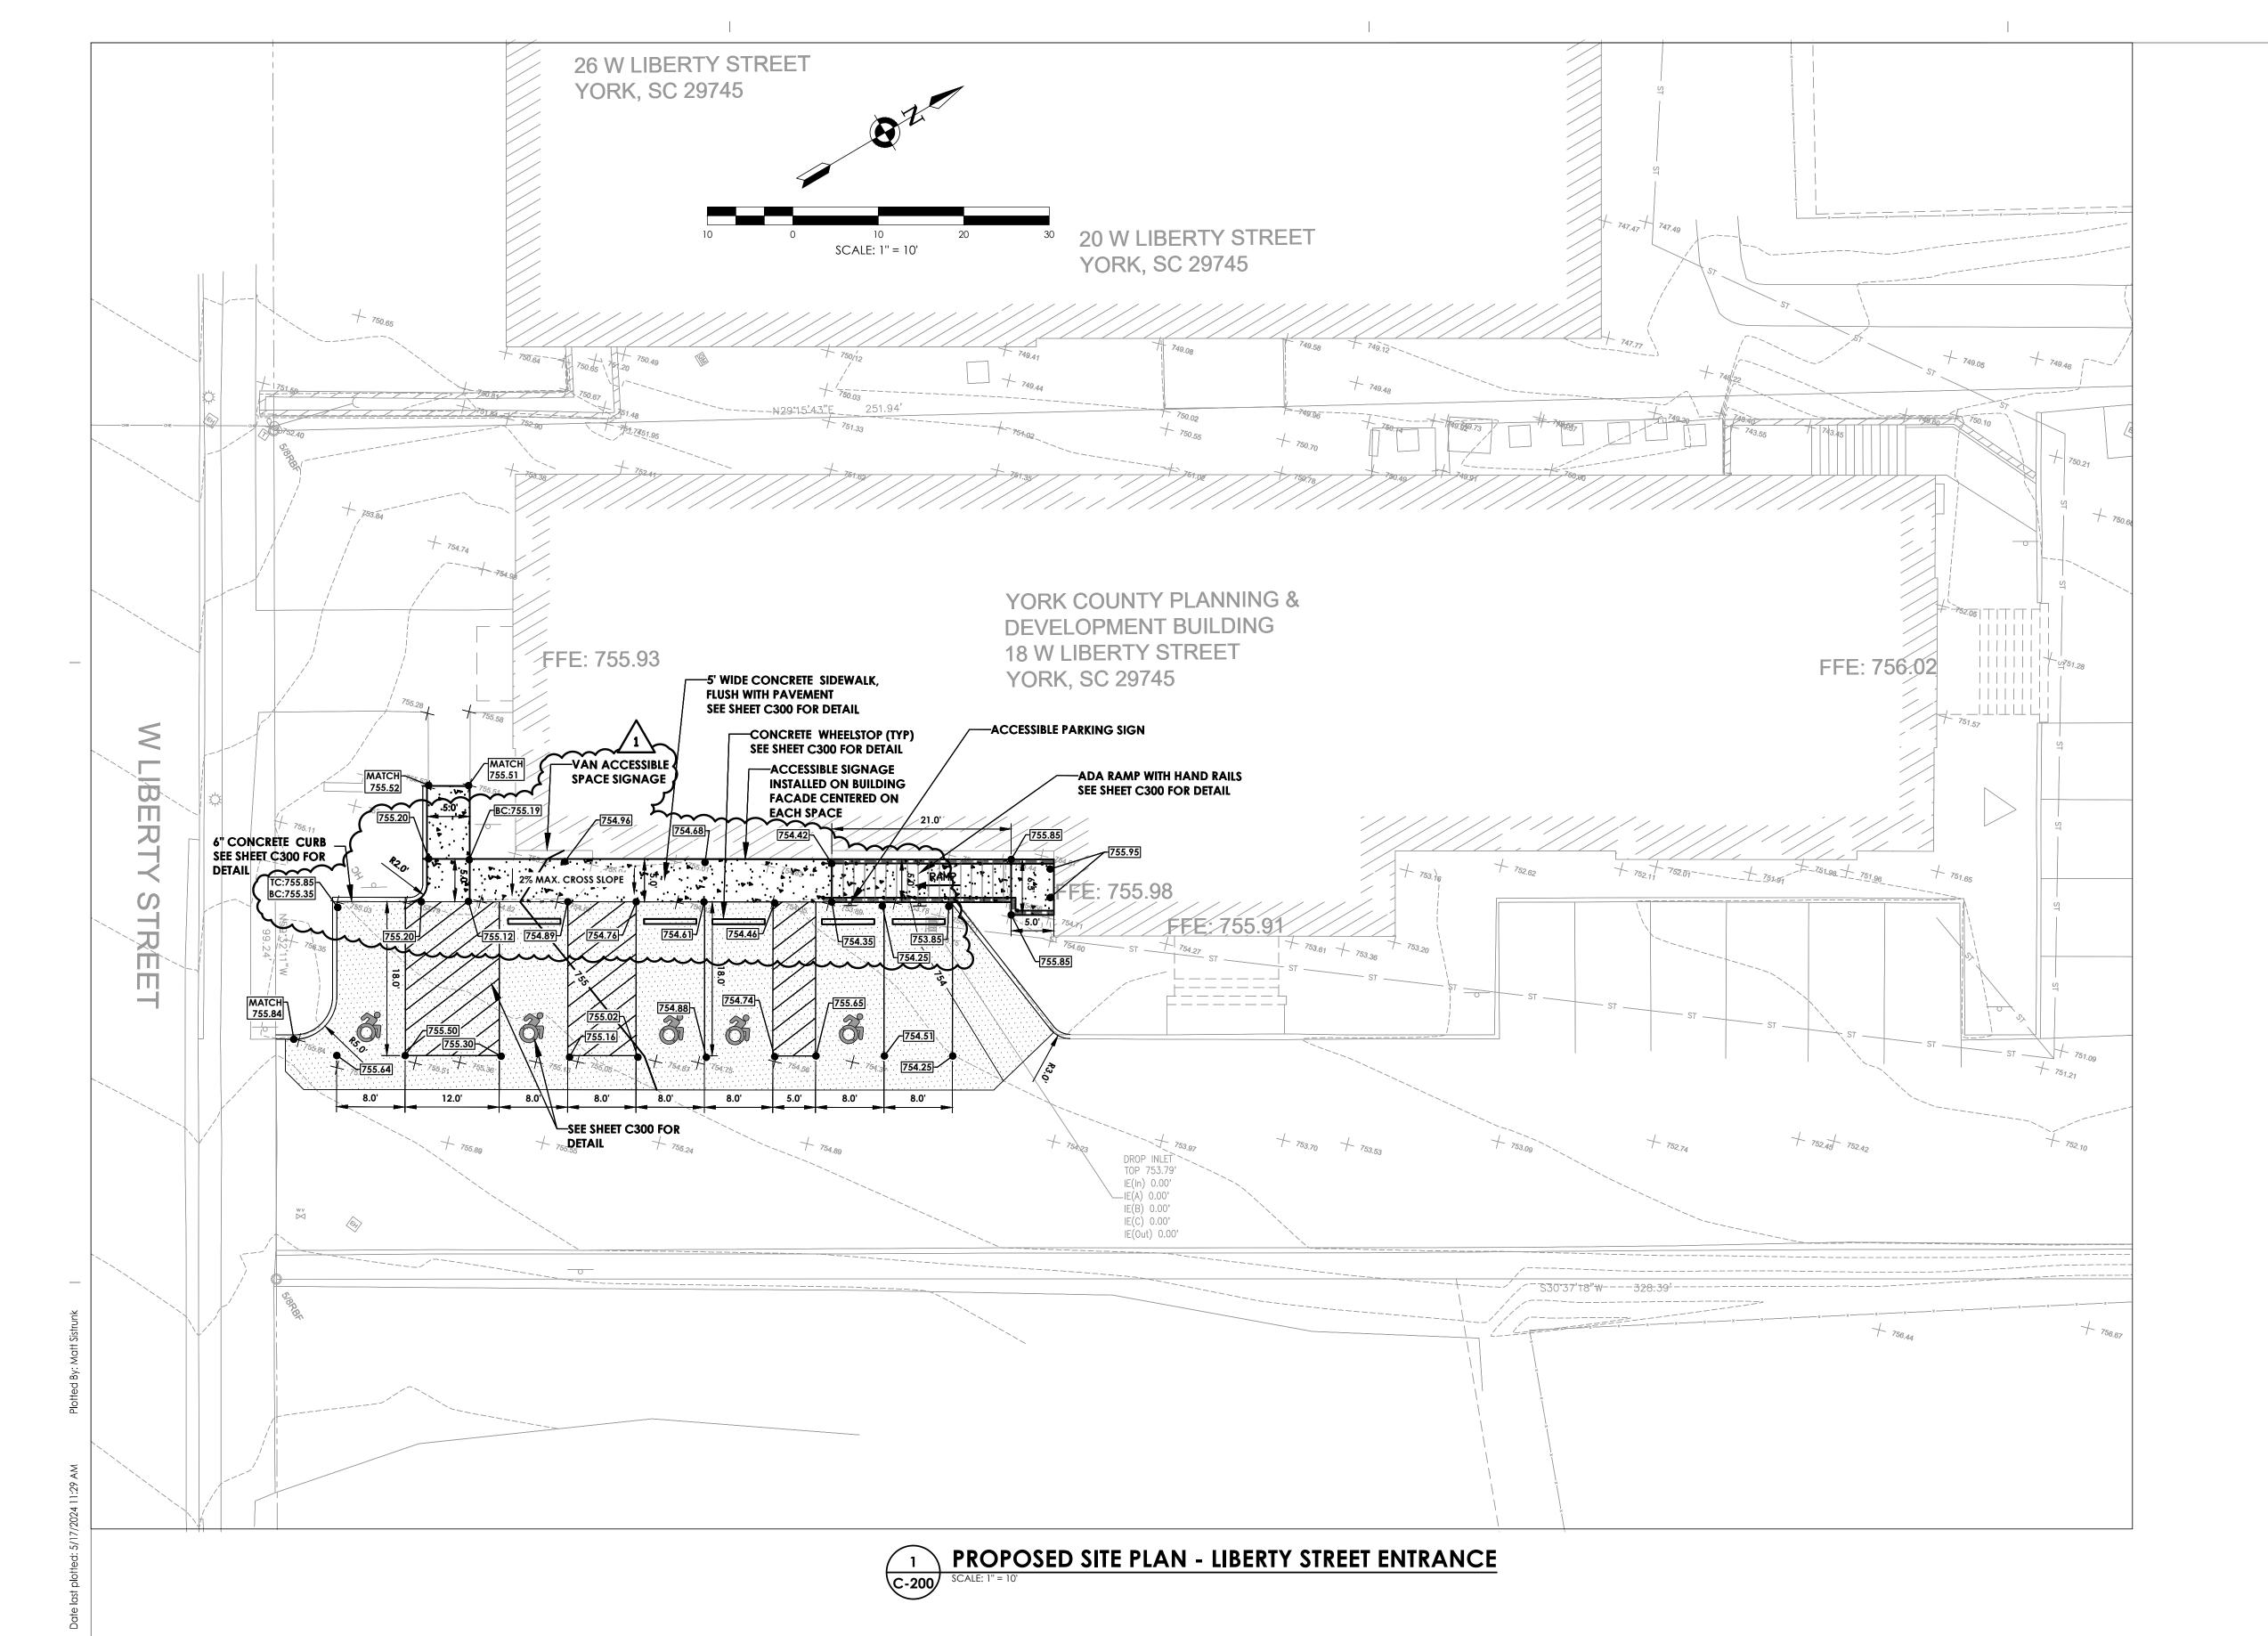

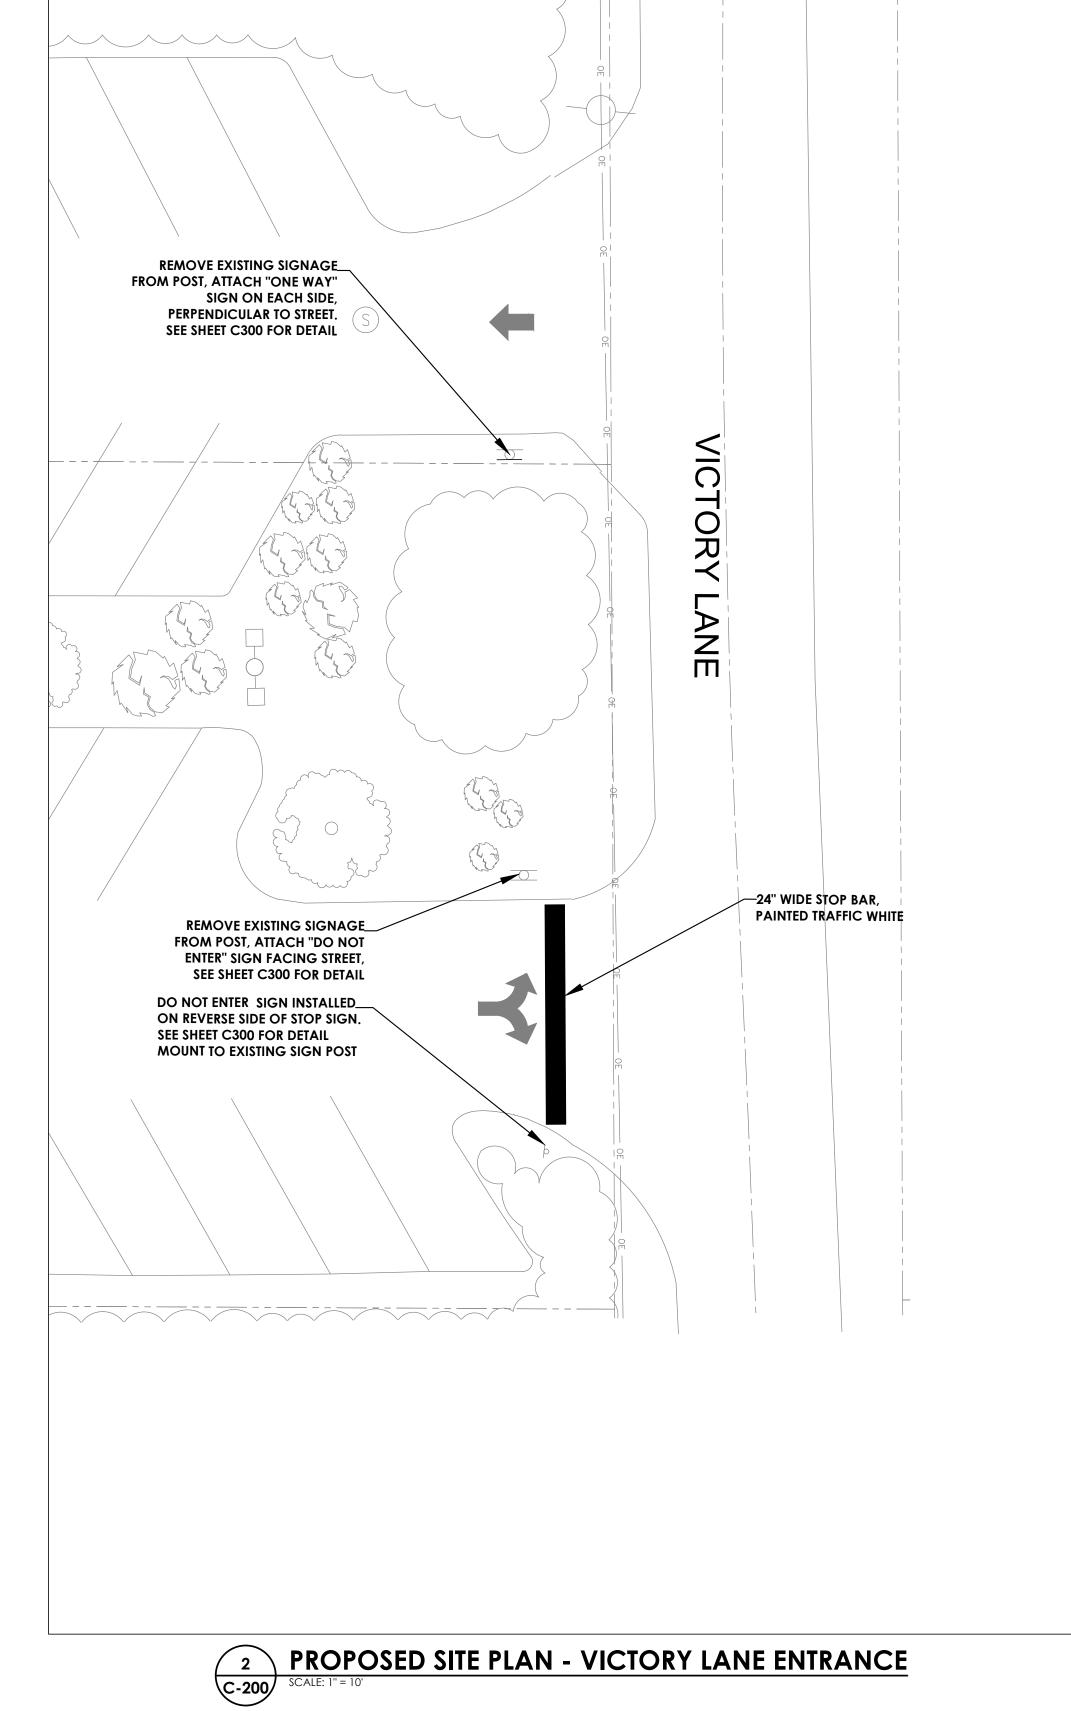

**LEGEND** 

PROPOSED CONCRETE SIDEWALK

PROPOSED ASPHALT PAVEMENT PROPOSED 6" CONCRETE CURB

#### SITE NOTES:

SEALANT IS APPLIED.

- 1. ALL WORK AND MATERIALS SHALL COMPLY WITH ALL APPLICABLE CITY OF YORK, YORK COUNTY AND SOUTH CAROLINA REGULATIONS, CODES AND O.S.H.A. STANDARDS.
- 2. PROPERTY IS NOT LOCATED IN A FLOOD HAZARD AREA AS PER F.E.M.A. FLOOD INSURANCE MAP PANEL NUMBER 45091C0276E DATED 9/28/2008.
- 3. ALL DIMENSIONS SHOWN ARE TO FACE OF BUILDING, TO FACE OF CURB, TO CENTERLINE OF STRIPING, TO PROPERTY LINE OR CORNER, UNLESS OTHERWISE NOTED. 4. JOINT SEALANTS SHALL BE INSTALLED FOR ALL EXPANSION JOINTS IN PAVERS SET WITH MORTAR, CAST-IN-PLACE CONCRETE, JOINTS BETWEEN DIFFERING MATERIALS, BETWEEN CURBS AND SIDEWALK, BETWEEN EXISTING AND PROPOSED CONCRETE PAVEMENTS, CONTROL AND EXPANSION JOINTS IN CAST-IN-PLACE CONCRETE, CONTROL

AND EXPANSION JOINTS IN UNIT MASONRY AND JOINTS IN MASONRY. PLASTIC ZIP CAPS SHALL BE REMOVED BEFORE

- 5. ALL MATERIAL SHALL BE NEW, UNUSED AND OF THE HIGHEST QUALITY IN EVERY RESPECT. THE EXCEPTIONS ARE AS FOLLOWS: SOME EXISTING LUMINARIES ARE TO BE RELOCATED. GATE, GATE MOTOR AND KEYPAD ARE TO BE
- 6. CONTRACTOR SHALL BE RESPONSIBLE FOR CHECKING CONTRACT DOCUMENTS, FIELD CONDITIONS AND DIMENSIONS FOR ACCURACY AND CONFIRMING THAT THE PROJECT IS BUILDABLE AS SHOWN BEFORE PROCEEDING WITH CONSTRUCTION. IF THERE ARE ANY QUESTIONS, THE CONTRACTOR SHALL SUBMIT THEM IN WRITING TO THE ENGINEER OR OWNER'S REPRESENTATIVE. THE CONTRACTOR SHALL BE RESPONSIBLE FOR OBTAINING WRITTEN CLARIFICATION FROM THE ENGINEER OR OWNER'S REPRESENTATIVE BEFORE PROCEEDING WITH THE WORK IN
- 7. ALL SITE WORK CONCRETE SHALL BE MINIMUM 4000 PSI 28 DAY STRENGTH.

  8. CONCRETE SCORE LINES SHALL BE EQUALLY SPACED WITHIN EACH CONCRETE PANEL, AT NO FURTHER THAN 6'
- MAXIMUM SPACING, AND AS CLOSE TO 4'X4' JOINTING AS POSSIBLE. SEE PLANS FOR TYPICAL LOCATIONS.
- 9. AS SOON AS CONCRETE HAS BEEN FLOATED LEVEL AND SMOOTH AND HAS BEGUN TO SET UP, APPLY A LIGHT BROOM FINISH IN A CONSISTENT DIRECTION PERPENDICULAR TO THE DIRECTION OF PRIMARY PEDESTRIAN TRAVEL.
- 10. ALL EXPANSION JOINTS ARE ½" PREMOLDED BITUMINOUS ASPHALT WITH A BACKER ROD AND JOINT SEALER. 11. CONCRETE CRACK CONTROL JOINTS SHALL BE SAWCUT. SAWCUTTING MUST OCCUR THE SAME DAY THE CONCRETE IS POURED AND AS SOON AS IT CAN SUPPORT THE WEIGHT OF A PERSON WITH A SAW. PRIOR TO SAWCUTTING, CONTRACTOR SHALL CHALK LAYOUT JOINTS. CONTRACTOR SHALL SUBMIT SAWCUT PLAN TO ENGINEER FOR APPROVAL PRIOR TO INSTALLATION.
- 12. ALL EXPANSION AND CONTROL JOINTS SHALL ALIGN WHEREVER PROPOSED WORK MEETS EXISTING. 13. ALL ACCESSIBLE RAMPS SHALL HAVE DETECTABLE WARNING SURFACES MEETING GDOT SPECIFICATIONS.
- 14. EROSION, SEDIMENT & POLLUTION CONTROL MEASURES SHALL BE ERECTED PRIOR TO ANY LAND DISTURBANCE ACTIVITY AND SHALL BE MAINTAINED THROUGHOUT THE DURATION OF THE PROJECT CONSTRUCTION UNTIL PERMANENT VEGETATIVE COVER HAS BEEN ESTABLISHED. CLEAN OUT AND REMOVE ALL ACCUMULATED SILT AND
- SEDIMENT WHENEVER SAID DEVICES ARE HALF FULL. 15. ALL CONSTRUCTION SURVEYING (INCLUDING LAYOUT) SHALL BE PERFORMED BY A LAND SURVEYOR WITH A CURRENT REGISTRATION AND LICENSURE IN THE STATE OF GEORGIA. CONTRACTOR REQUIRED TO OBTAIN CERTIFIED AS-BUILTS OF LIGHT POLE BASE LOCATIONS AND BOLT PATTERNS AND CONFIRM WITH MANUFACTURER.

PROFESSIONAL STAMPS



325 W. McBee Avenue, Suite 300 Greenville, SC 29601

PROJECT INFORMATION

Project Number

Project Name

Project Address

R23.00292.00

YORK COUNTY

**RENOVATION** 

18 LIBERTY STREET, YORK, SC

**PROJECT ISSUE & REVISION SCHEDULE** 

1 5/16/24 REV1 - PLAN REVIEW COMMENTS

PLANNING DEPARTMENT

SHEET INFORMATION 1" = 10**'** 4/16/2024

Proiect Status 100% CONSTRUCTION DOCUMENTS Drawn By CPL CPL

Drawing Title SITE AND GRADING PLAN

CONCRETE CURB

4. CONCRETE SEALING AGENT SHALL BE APPLIED THE SAME DAY THAT CURBS ARE

TO A DEPTH OF 1/2 INCH BELOW THE SURFACE OF THE CURB.

CONFORM TO THE CROSS SECTION OF THE CURB.

CONCRETE FINISHING TOOLS.

3. EXPANSION JOINTS AND FORMED CONTRACTION JOINTS ARE TO BE EDGED WITH

1. CONTRACTION JOINTS TO BE AT 10 FOOT INTERVALS AND SHALL BE FORMED OR SAW CUT

2. EXPANSION JOINTS TO BE AT 50 FOOT INTERVALS AND SHALL BE FORMED WITH 3/4 INCH

WIDE PREMOLDED BITUMINOUS JOINT FILLER. THE FILLER MATERIAL SHALL BE CUT TO

**VARIES-REFER TO SITE PLAN** OR MATCH EXISTING

SLOPE TO ROAD 1/4"/FT.

**CROSS-SECTIONAL VIEW** 

5'-0" OR AS SHOWN

ON SITE PLAN

25'-0" TO NEXT EXPANSION JOINT

JOINT FILLER WITH CAULK AGAINST AU
BUILDING WALLS AND END OF EACH POUR

ALL SIGN DESIGNATION PER "MANUAL OF UNIFORM TRAFFIC CONTROL DEVICES".

`— R=1/2"

COMPACTED SUBGRADE

— 6" SUBBASE

2" MINIMUM DEPTH

**FULL WIDTH OF** 

CONCRETE SLAB.

R3-12

- 4000 PSI CONCRETE

BASE COURSE

4000 PSI CONCRETE 4" THICK IN LAWN AREA, 6" THICK IN DRIVEWAY AREAS,

UNLESS NOTED OTHERWISE ON PLANS.

6"x6"xw1.4xw1.4

EXPANSION JOINT

WELDED WIRE MESH

6" AGGREGATE BASE COURSE -

5'-0" OR AS SHOWN

ON SITE PLAN

1/2" PREMOULDED RESILIENT

TYPICAL CONCRETE SIDEWALK

ENTER

W3-3

TRAFFIC SIGN DETAIL

MATCH EXISTING


**PAVEMENT SECTIONS** 


FULL WIDTH OF CONCRETE SLAB





## SAWCUT JOINT DETAIL




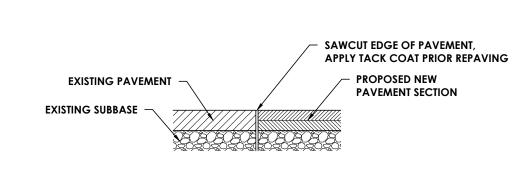

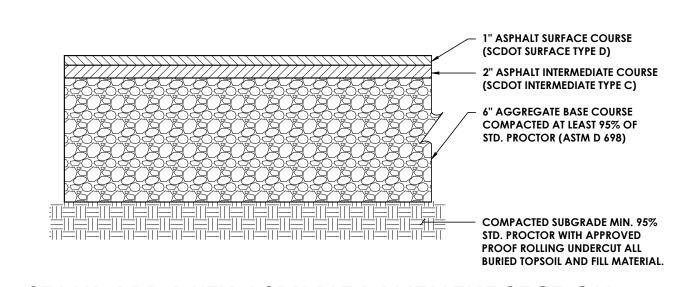

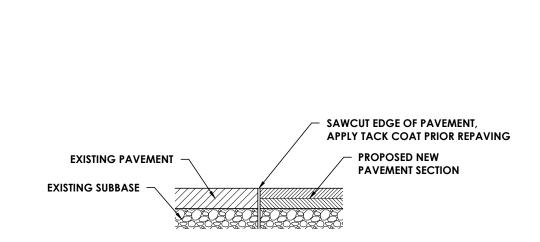

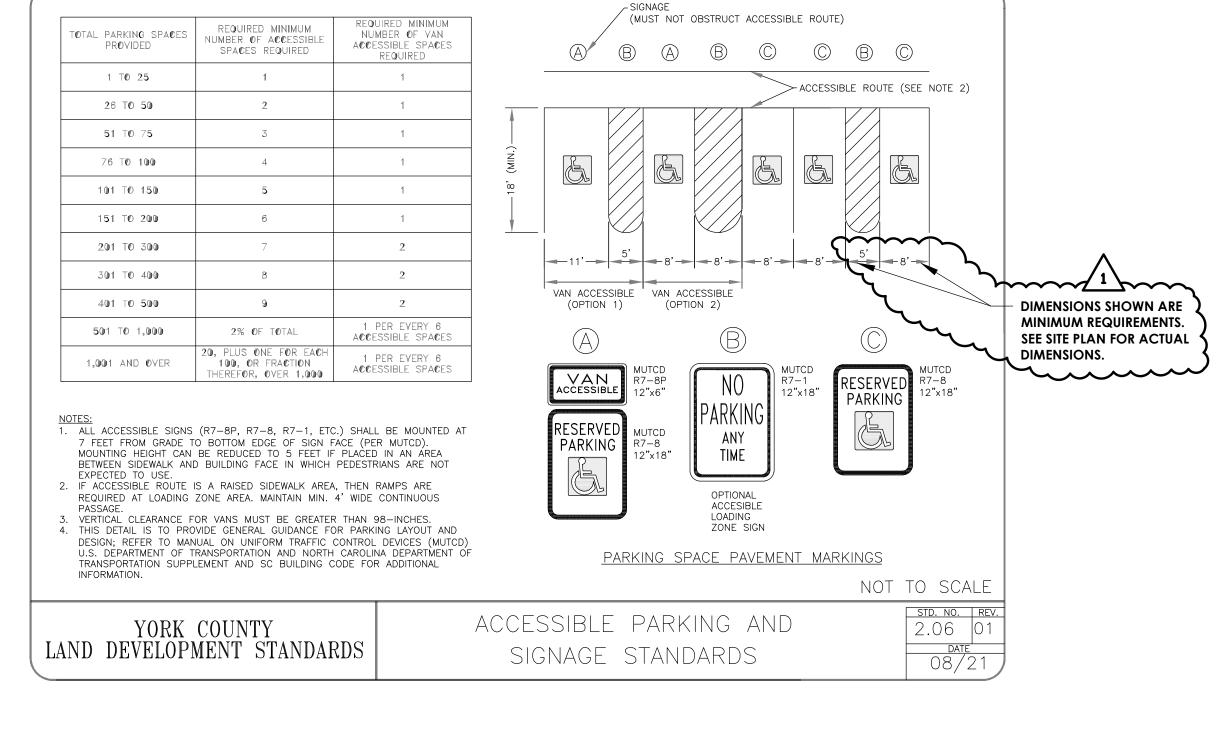

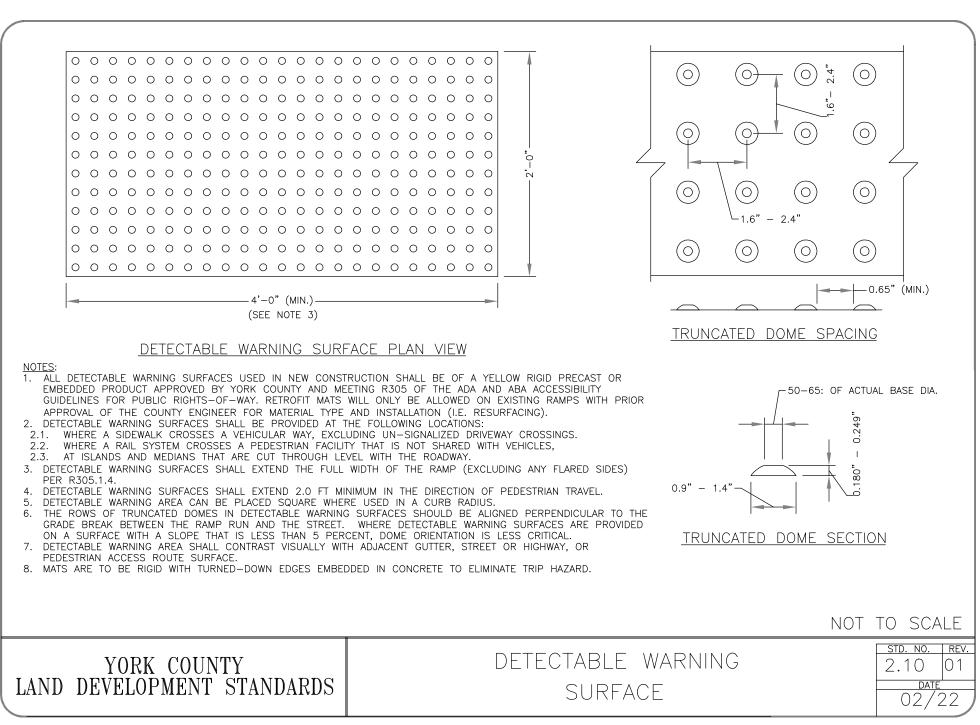


## 6' PRECAST CONCRETE PARKING BUMPER

4000 PSI. PRECAST CONCRETE PARKING BUMPER


#4 REBARS 2'-0" LONG

(2 PER STOP) —


ASPHALT PAVING -

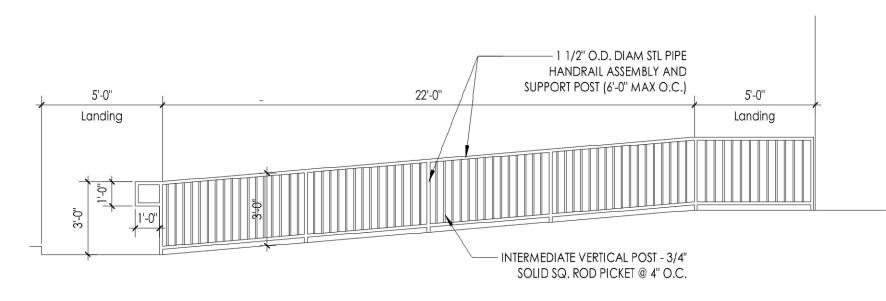

#### RAMP HANDRAIL

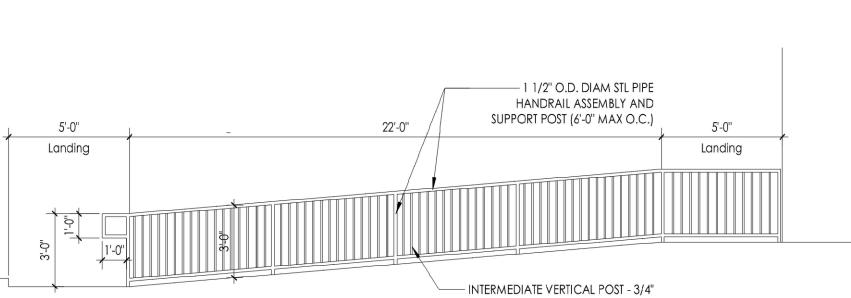

**ENLARGED RAMP** 

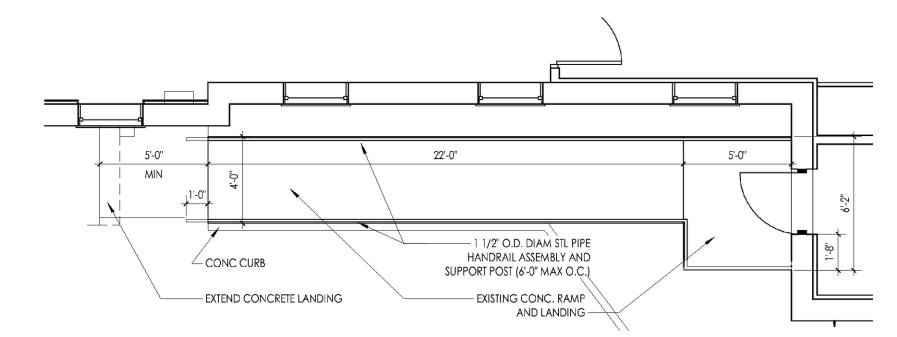



CPL | Architecture Engineering Planning

PROJECT INFORMATION Project Number R23.00292.00 Client Name

YORK COUNTY

Project Name PLANNING DEPARTMENT RENOVATION


Project Address

18 LIBERTY STREET, YORK, SC

PROJECT ISSUE & REVISION SCHEDULE 1 5/16/24 REV1 - PLAN REVIEW COMMENTS



SHEET INFORMATION **AS NOTED** 4/16/2024 Proiect Status 100% CONSTRUCTION DOCUMENTS Drawn By Checked By CPL CPL Drawing Title SITE CIVIL DETAILS

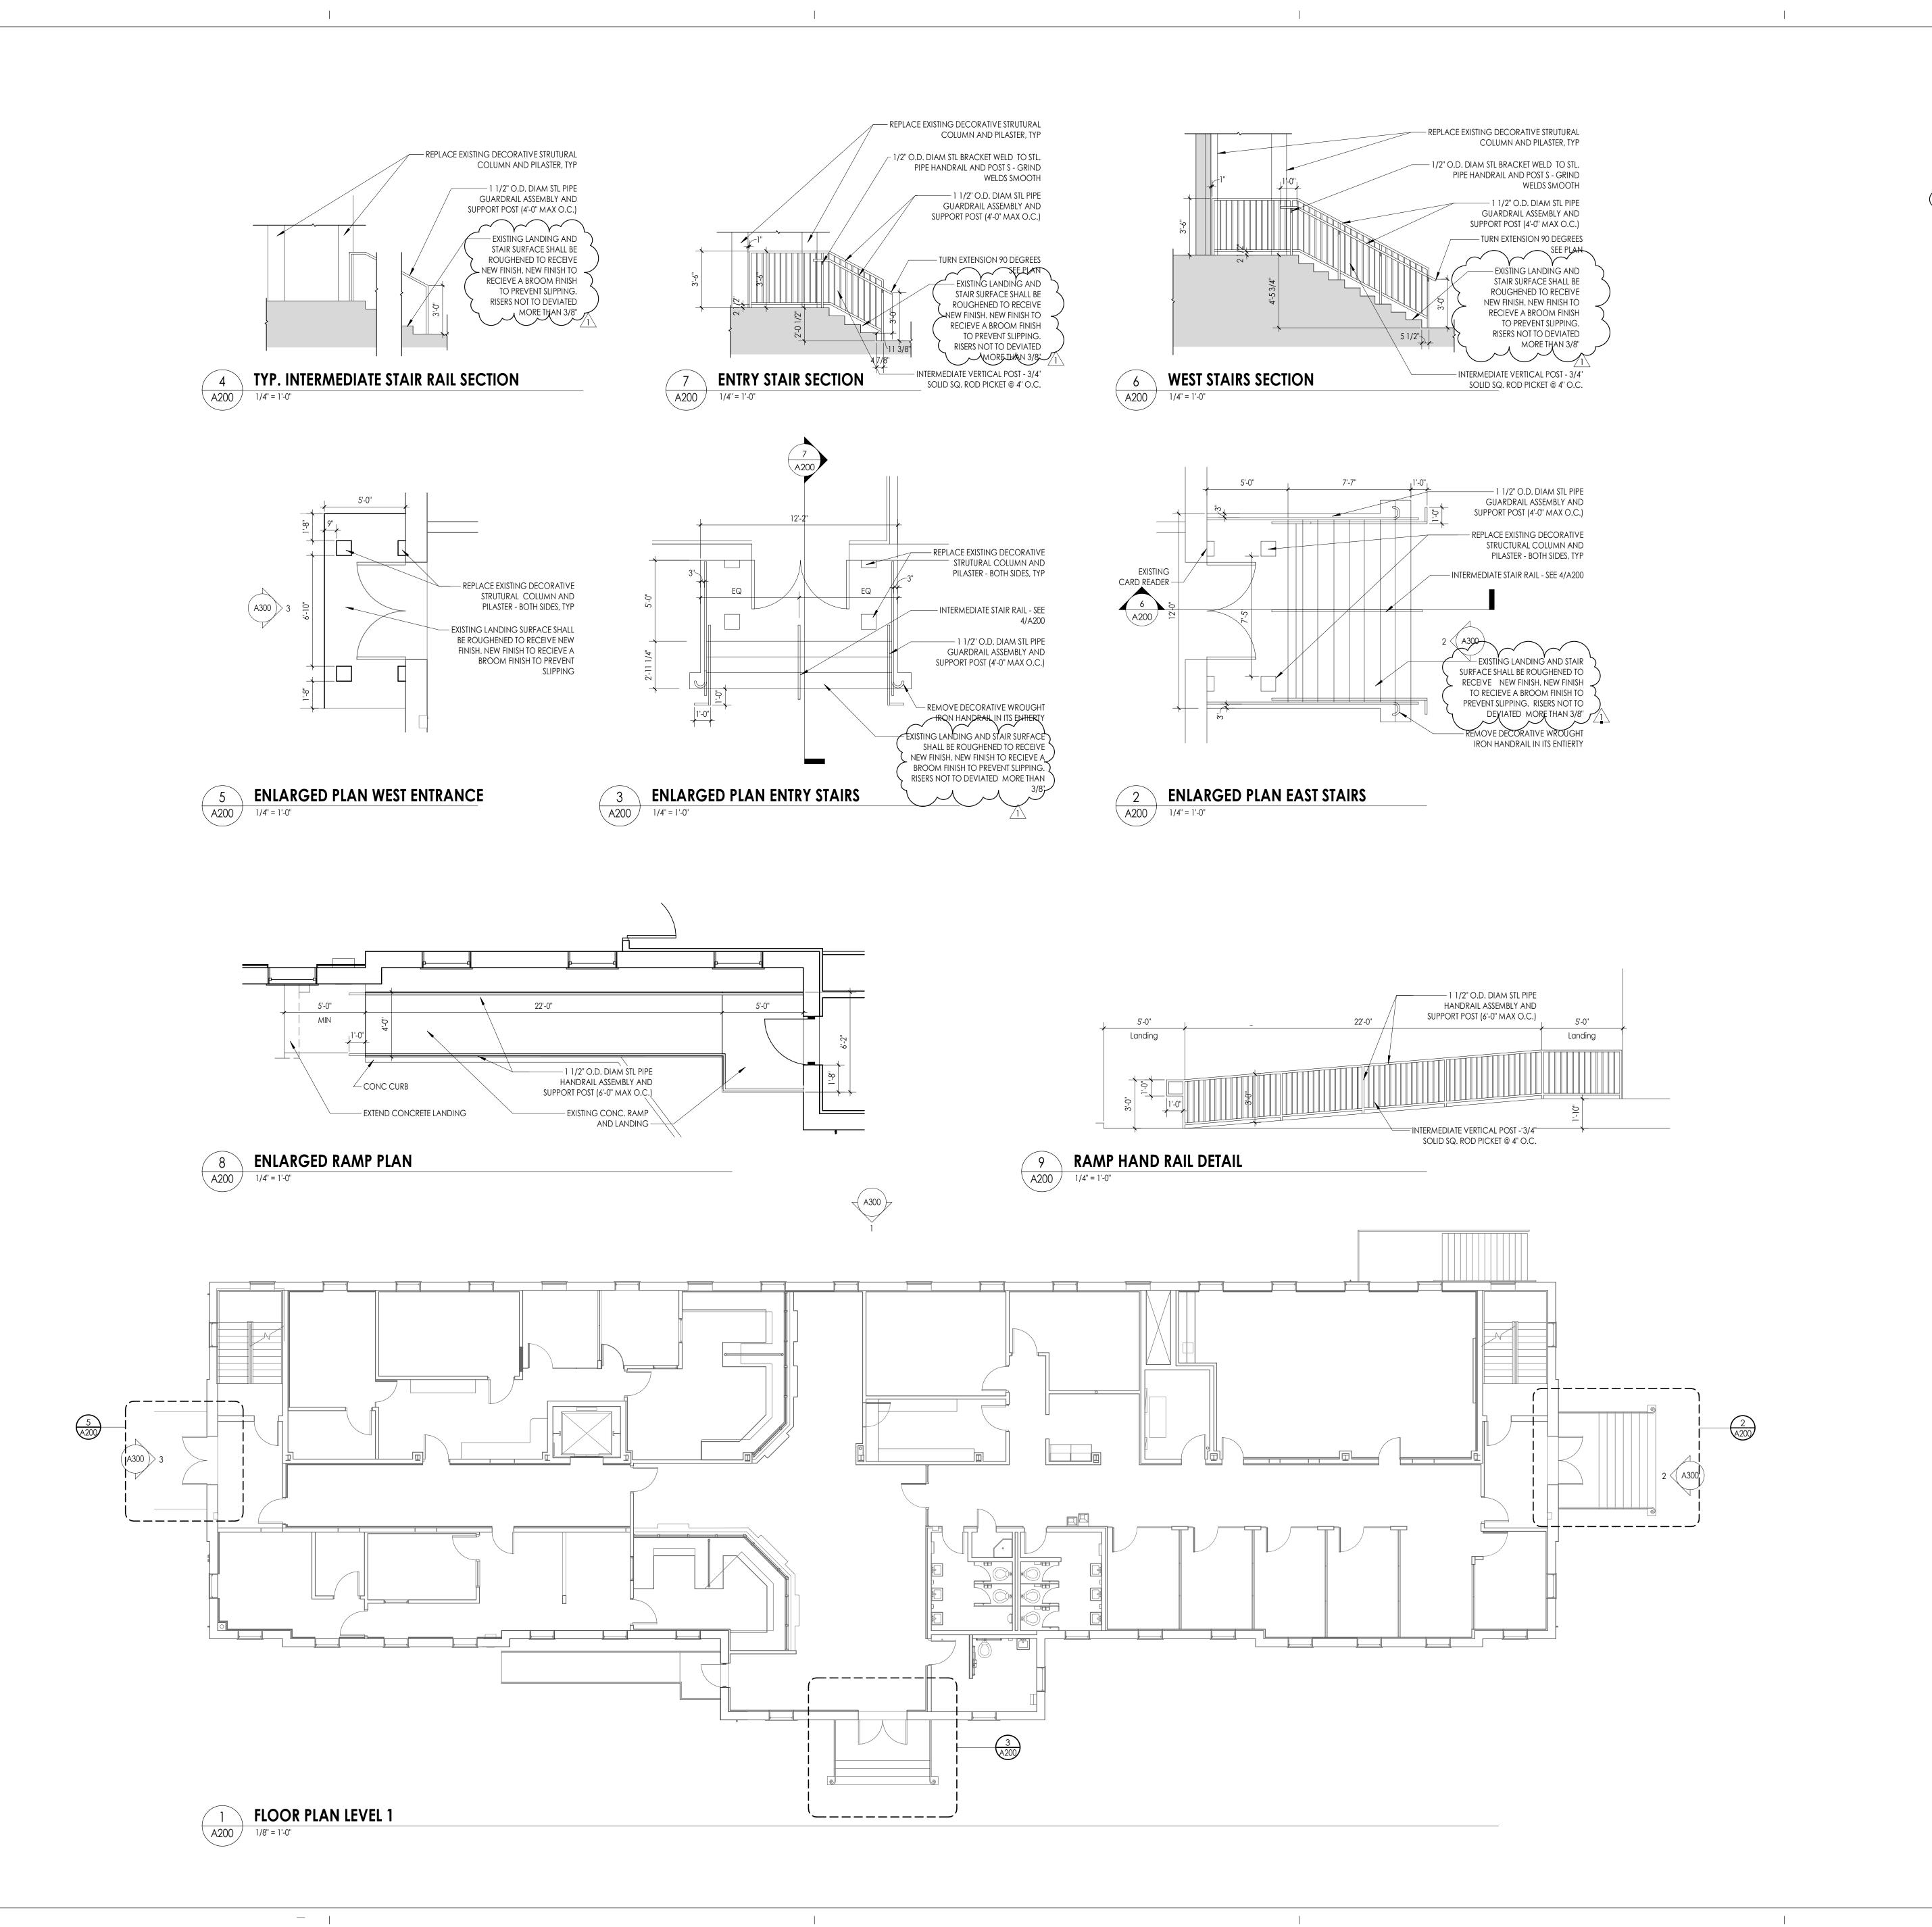

#### FLOOR PLAN GENERAL NOTES

. ALL DRAWINGS ARE GRAPHIC REPRESENTATIONS OF APPROXIMATE LOCATIONS OF NEW MATERIALS. FIELD VERIFY ALL EXISTING CONDITIONS PRIOR TO COMMENCEMENT 2. ALL WALL DIMENSIONS INDICATED ON FLOOR PLANS ARE FROM FACE OF FINISH TO FACE OF FINISH UNLESS OTHERWISE NOTED. 3. WORK AREAS SHALL BE MAINTAINED AND ALL WORK AREAS SHALL BE LEFT BROOMED CLEAN AT END OF EACH DAY.

4. COORDINATE WITH OTHER TRADES FOR SEQUENCING OF WORK. 5. EQUIPMENT SHOWN ON THESE DOCUMENTS ARE FOR REFERENCE ONLY AND ARE FOR COORDINATION OF M,E,P INFRASTRUCTURE TO OPERATE ITEMS INCLUDED UNDER THE

FLOORS FOR NEW AUXISMES. handrails and güards shall be designed to resist a concentrated load o 200 POUNDS PER IBC 1607.9

CPL | Architecture Engineering Planning 6302 Fairview Road Suite 102, Charlotte, NC 28210 CPLteam.com

PROJECT INFORMATION

R23.00292.00

Project Name

YORK COUNTY

RENOVATION

PLANNING DEPARTMENT

18 LIBERTY STREET, YORK, SC

#### FLOOR PLAN LEGEND

NOTE: THIS LEGEND MAY CONTAIN SYMBOLS THAT ARE NOT USED IN THIS PROJECT.

WINDOW TARGET, SEE SCHEDULE COLUMN LINE IDENTIFICATION **ROOM NAME** 150 SF **ROOM TAG** 

10'-0" x 10'-0"

XXX - XXX DENOTES CHANGE IN FLOOR MATERIAL


WATER HEATER/ AIR HANDLER, SEE MECHANICAL SECTION MARK



INTERIOR ELEVATION MARK



EXTERIOR ELEVATION MARK

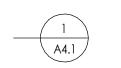

DETAIL FOR REFERENCE MARK

PROJECT ISSUE & REVISION SCHEDULE

# Date Description 1 5/16/2024 Plan Review Comments

PROFESSIONAL STAMPS







SHEET INFORMATION

04/16/2024 Project Status 100% CONSTRUCTION DOCUMENTS


FLOOR PLAN AND ENLARGED FLOOR PLANS

Drawing Number

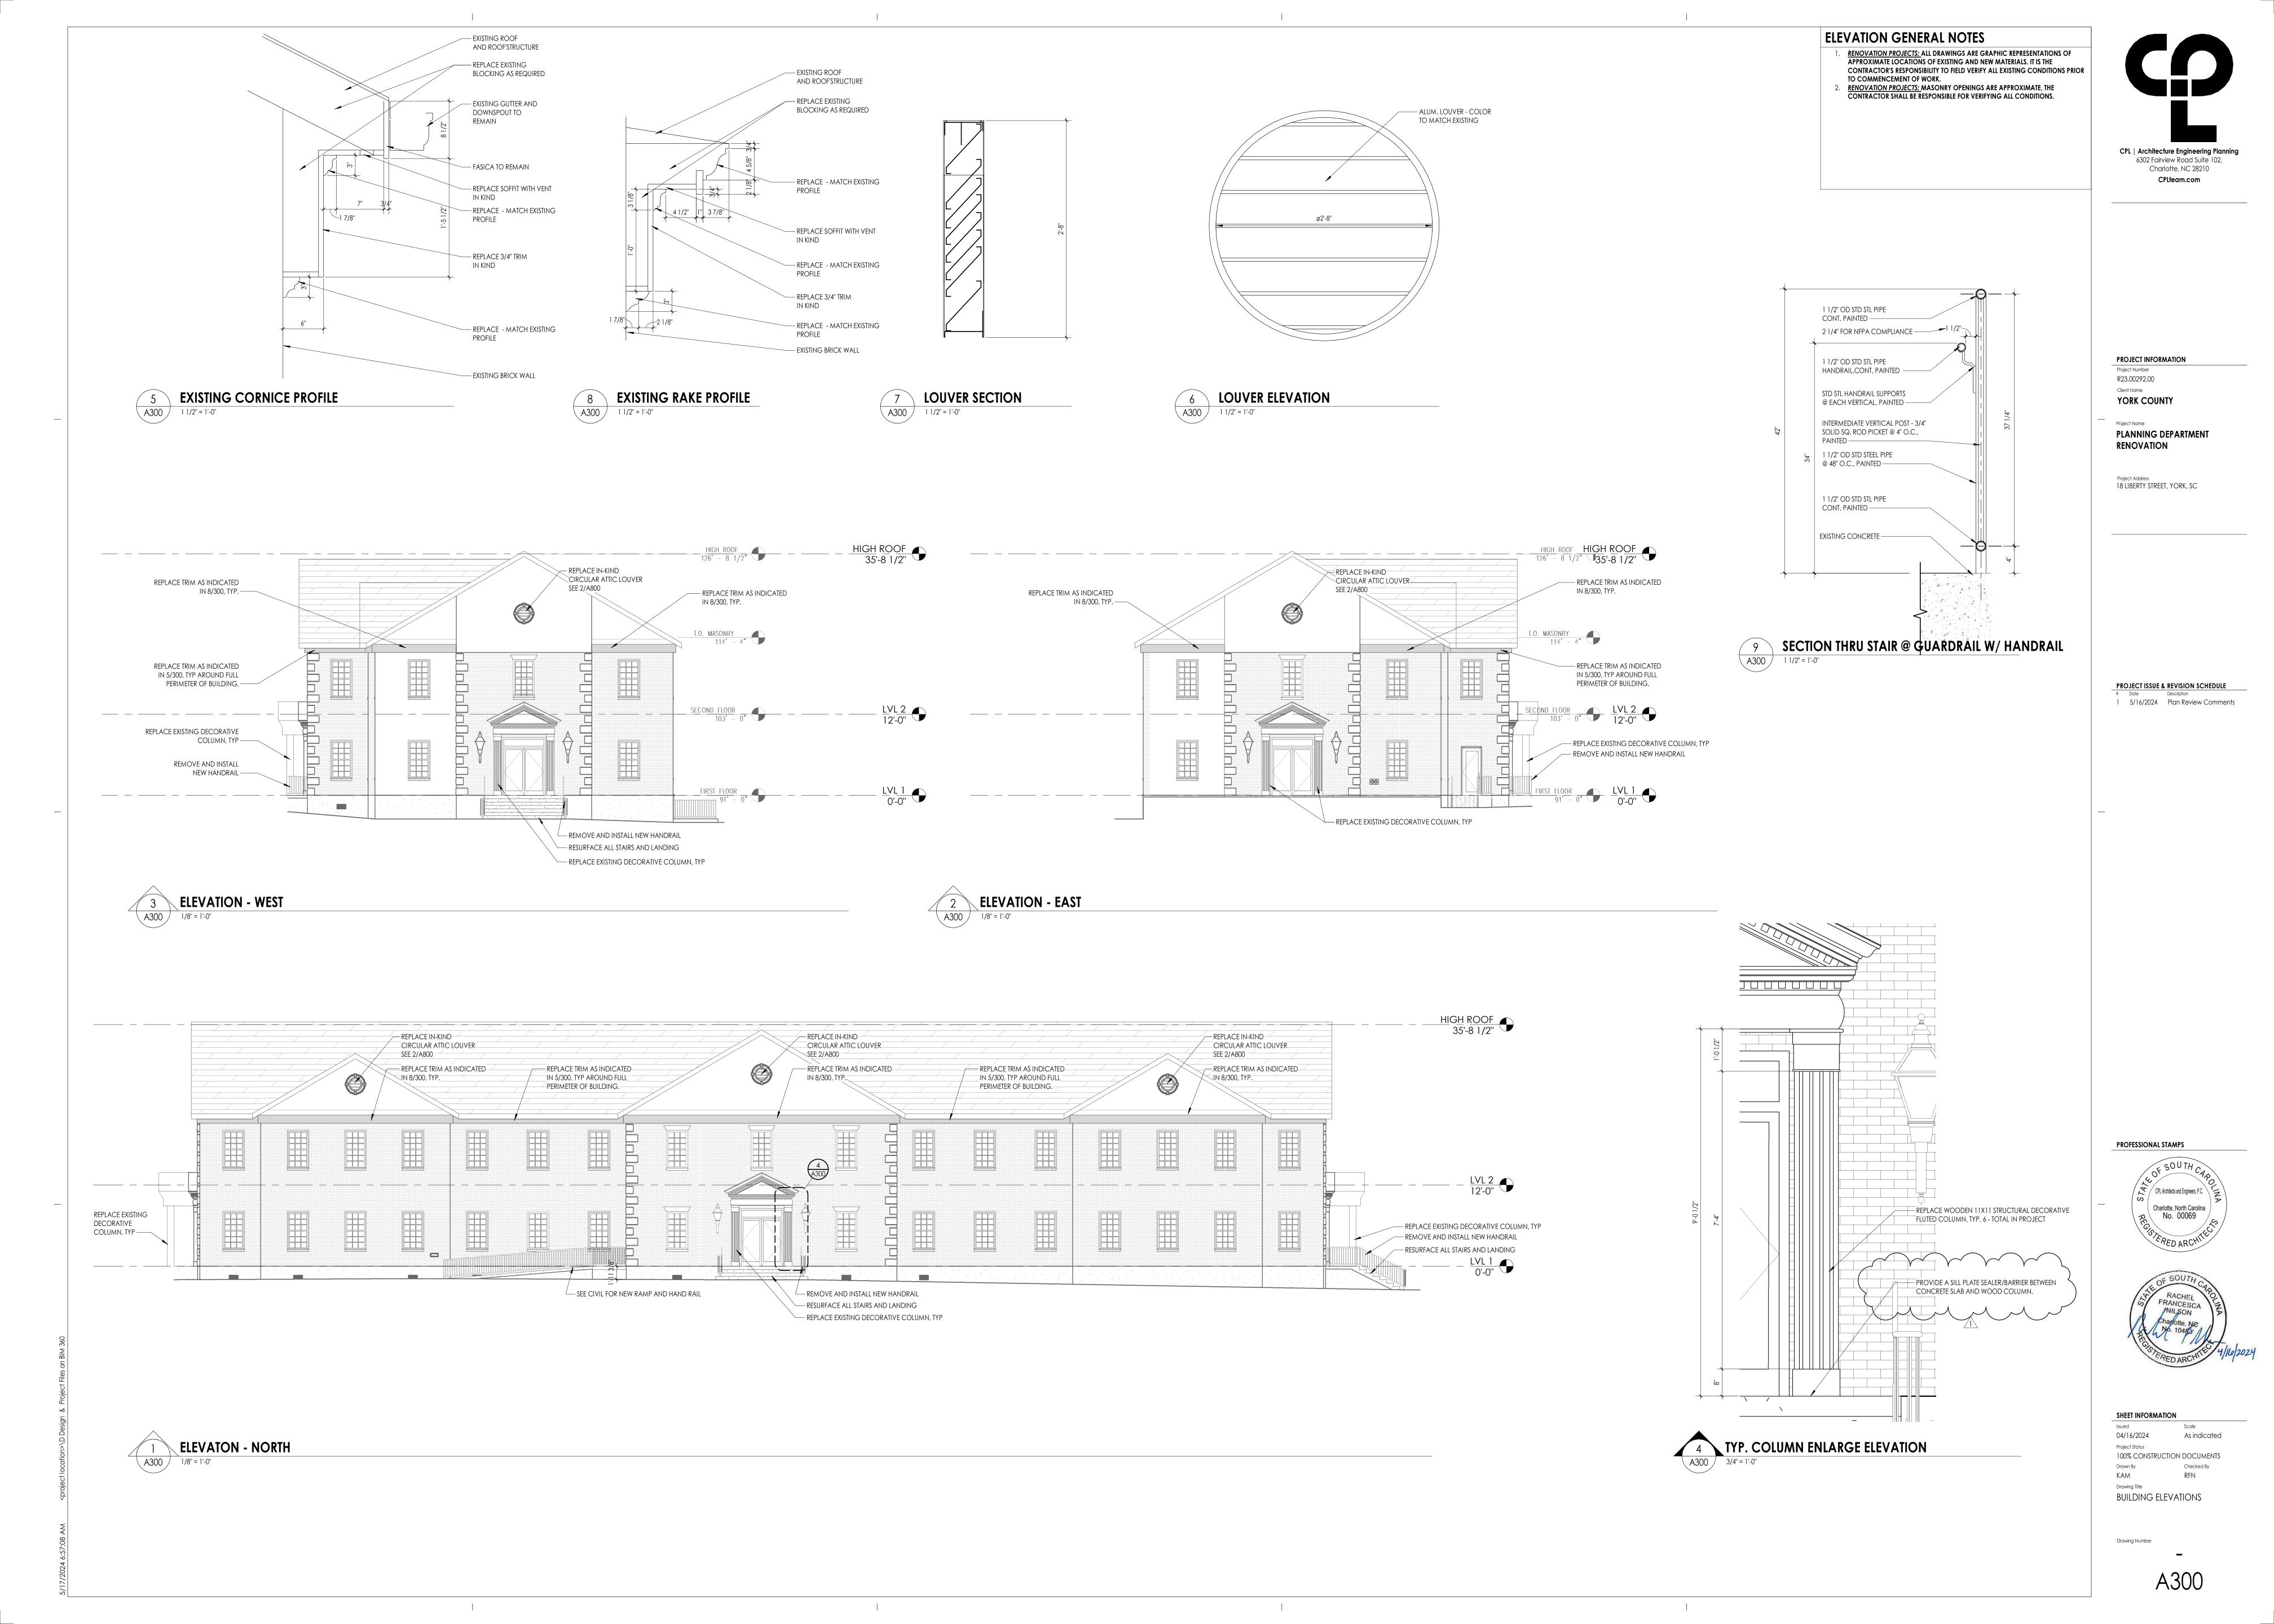

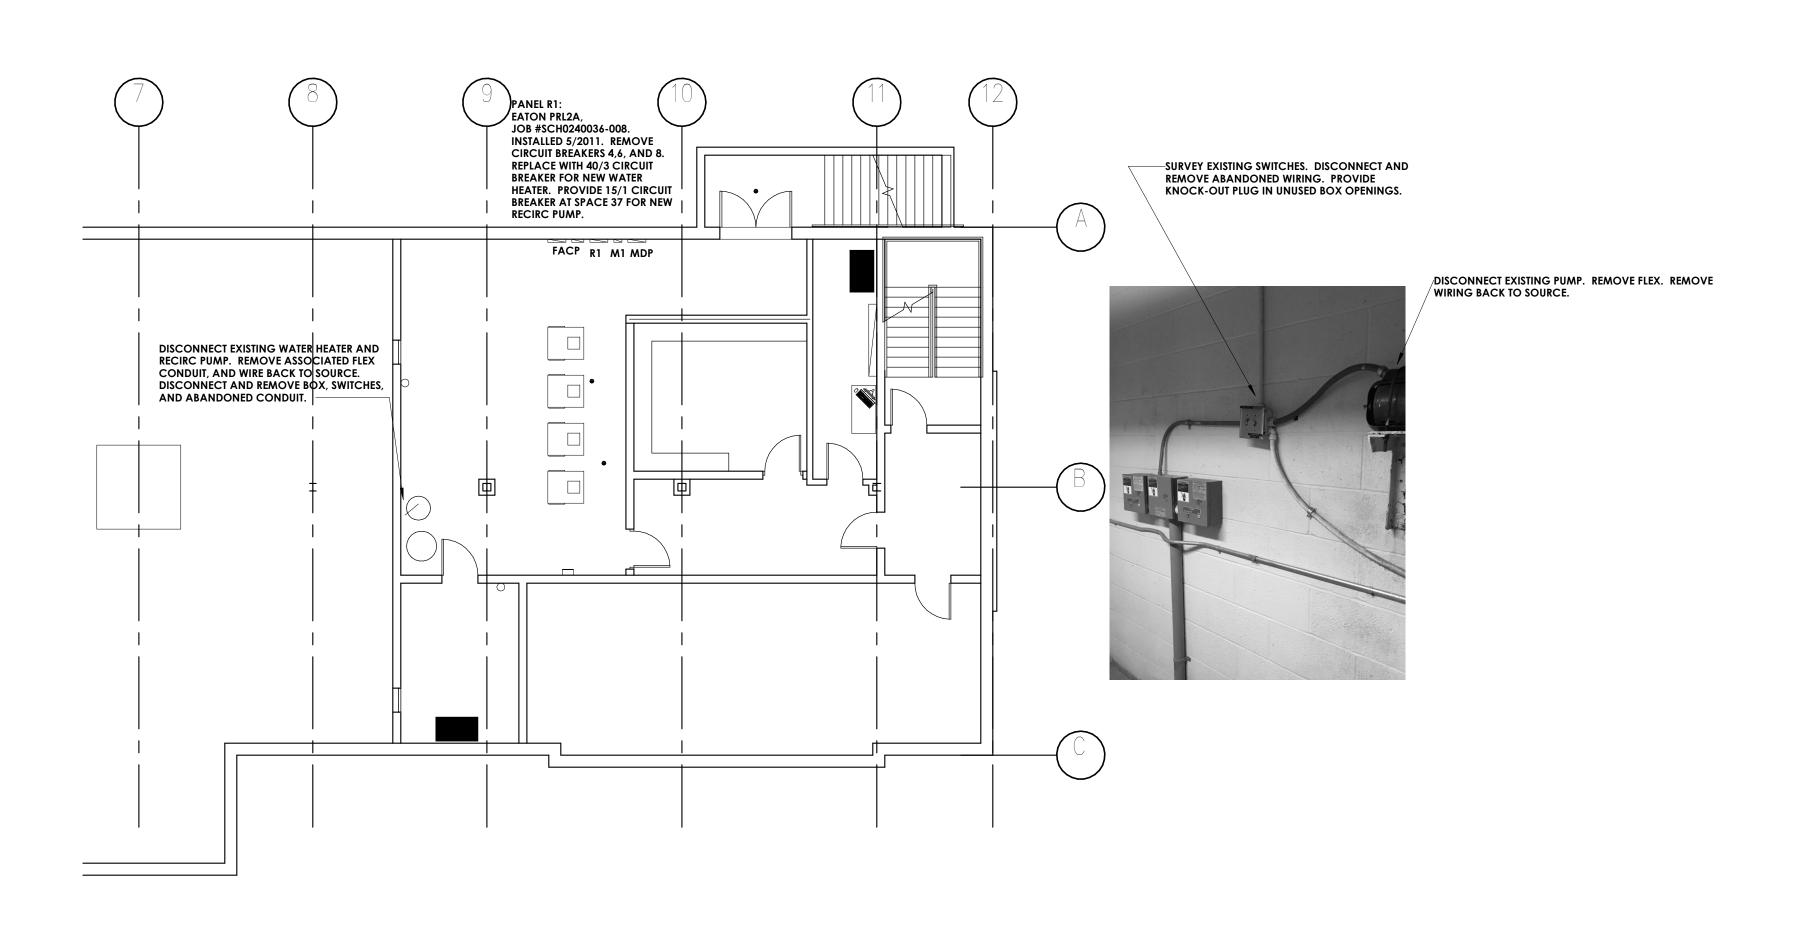

1 DEMO BASEMENT ELECTRICAL PLAN

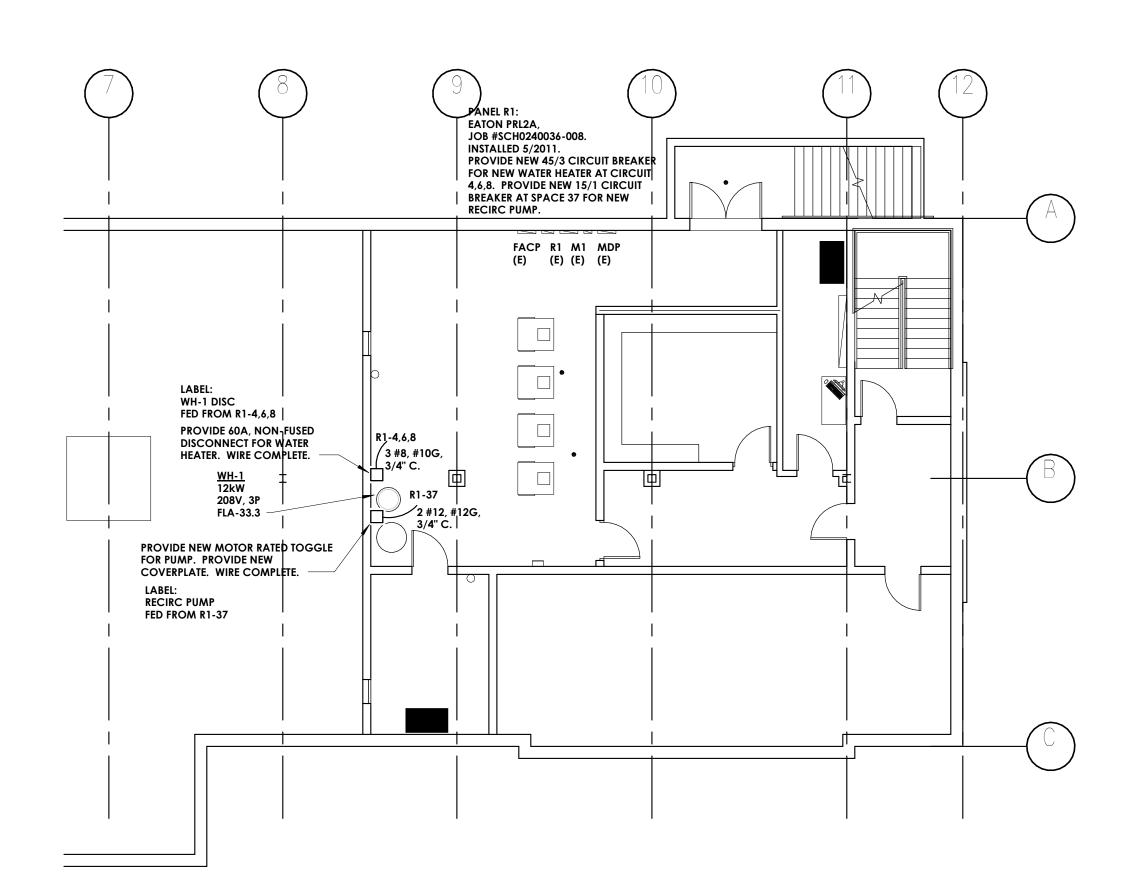

2 BASEMENT POWER PLAN

1/8" = 1'-0"

#### GENERAL DEMOLITION NOTES

- A. ONLY ITEMS NOTED TO BE REMOVED SHALL BE REMOVED. REMOVAL OF DEVICE INCLUDES ITS ASSOCIATED CABLING, BRANCH CIRCUIT WIRING, AND RACEWAY.
- B. ANY EXISTING DEVICE TO REMAIN, LABELED AS (E) SHALL REMAIN IN PLACE AS WELL AS ITS ASSOCIATED CIRCUITING AND CONDUIT, UNLESS OTHERWISE NOTED.
- C. WHERE DEVICES, FIXTURES, ETC. ARE INDICATED TO BE REMOVED, THEY AND THEIR RELATED WIRING/CONDUIT SHALL BE REMOVED BACK TO THE SOURCE PANELBOARD UNLESS OTHERWISE NOTED. ON CIRCUITS WHERE OTHER DEVICES, FIXTURES, ETC. ARE FOUND THAT MUST REMAIN, MAINTAIN CIRCUIT CONTINUITY BY PROVIDING ADDITIONAL WIRING, TO FEED THROUGH TO THESE REMAINING ITEMS. RELOCATE ANY CIRCUITS THAT REMAIN, TO AVOID CONFLICT WITH NEW CONSTRUCTION AS REQUIRED. PROPERLY TERMINATE ALL WIRING.
- D. COORDINATE DEMOLITION OF EQUIPMENT, DEVICES, ETC. WITH OTHER DISCIPLINES AS APPLICABLE. REFER TO ARCHITECTURAL DEMOLITION DRAWINGS AND NOTES FOR COORDINATION.
- E. DRAWINGS ARE GRAPHICAL REPRESENTATIONS OF APPROXIMATE EQUIPMENT AND DEVICE LOCATIONS. CONTRACTOR SHALL VISIT THE SITE TO DETERMINE THE EXACT EXTENT OF ELECTRICAL WORK REQUIRED TO COMPLETE THE PROJECT. EXISTING CONDITIONS ARE TAKEN FROM FIELD OBSERVATION AND EXISTING BUILDING DOCUMENTS. OTHER ELECTRICAL ITEMS MAY EXIST FOR WHICH THE CONTRACTOR IS RESPONSIBLE.
- CONTRACTOR SHALL PROVIDE NEW COVERPLATES ON ALL BOXES OF UNUSED AND/OR REMOVED FLUSH MOUNT DEVICES UPON COMPLETION OF PROJECT.
- G. FIREPROOFING AND/OR FIRE STOP MATERIALS REMOVED FROM FIRE RATED WALLS AND CEILINGS AS A RESULT OF DEMOLITION SHALL BE RE-INSTALLED USING AN APPROVED METHOD AS DESCRIBED IN ASSOCIATED PROJECT SPECIFICATIONS.
- H. ALL NEW WORK SHALL BE NEW AND SHALL BE UL LISTED.

  I. ALL WORK SHALL BE IN COMPLIANCE WITH THE 2020 NEC.

PROJECT INFORMATION

R23.00292.00 Client Name

YORK COUNTY

Project Name

PLANNING BUILDING

RENOVATION

CPL | Architecture Engineering Planning

400 Bellemeade Street Suite 401,

Greensboro, NC 27401

CPLteam.com

NC ENGINEERING FIRM LICENSE NO. C-2194

18 LIBERTY STREET, YORK, SC

PROJECT ISSUE & REVISION SCHEDULE

# Date Description

1 5/16/2024 PLAN REVIEW COMMENTS

PROFESSIONAL STAMPS



SHEET INFORMATION


| Issued | Scale | | O4/15/2024 | 1/8" = 1'-0" | | Project Status | 100% CONSTRUCTION DOCUMENTS | Drawn By | Checked By | | Checked By | | O5/100 | O5/100 | O5/100 | O5/100 | O5/100 | O5/100 | | O5/

Drawing Title
ELECTRICAL PLANS


Drawing Number


MSR

101

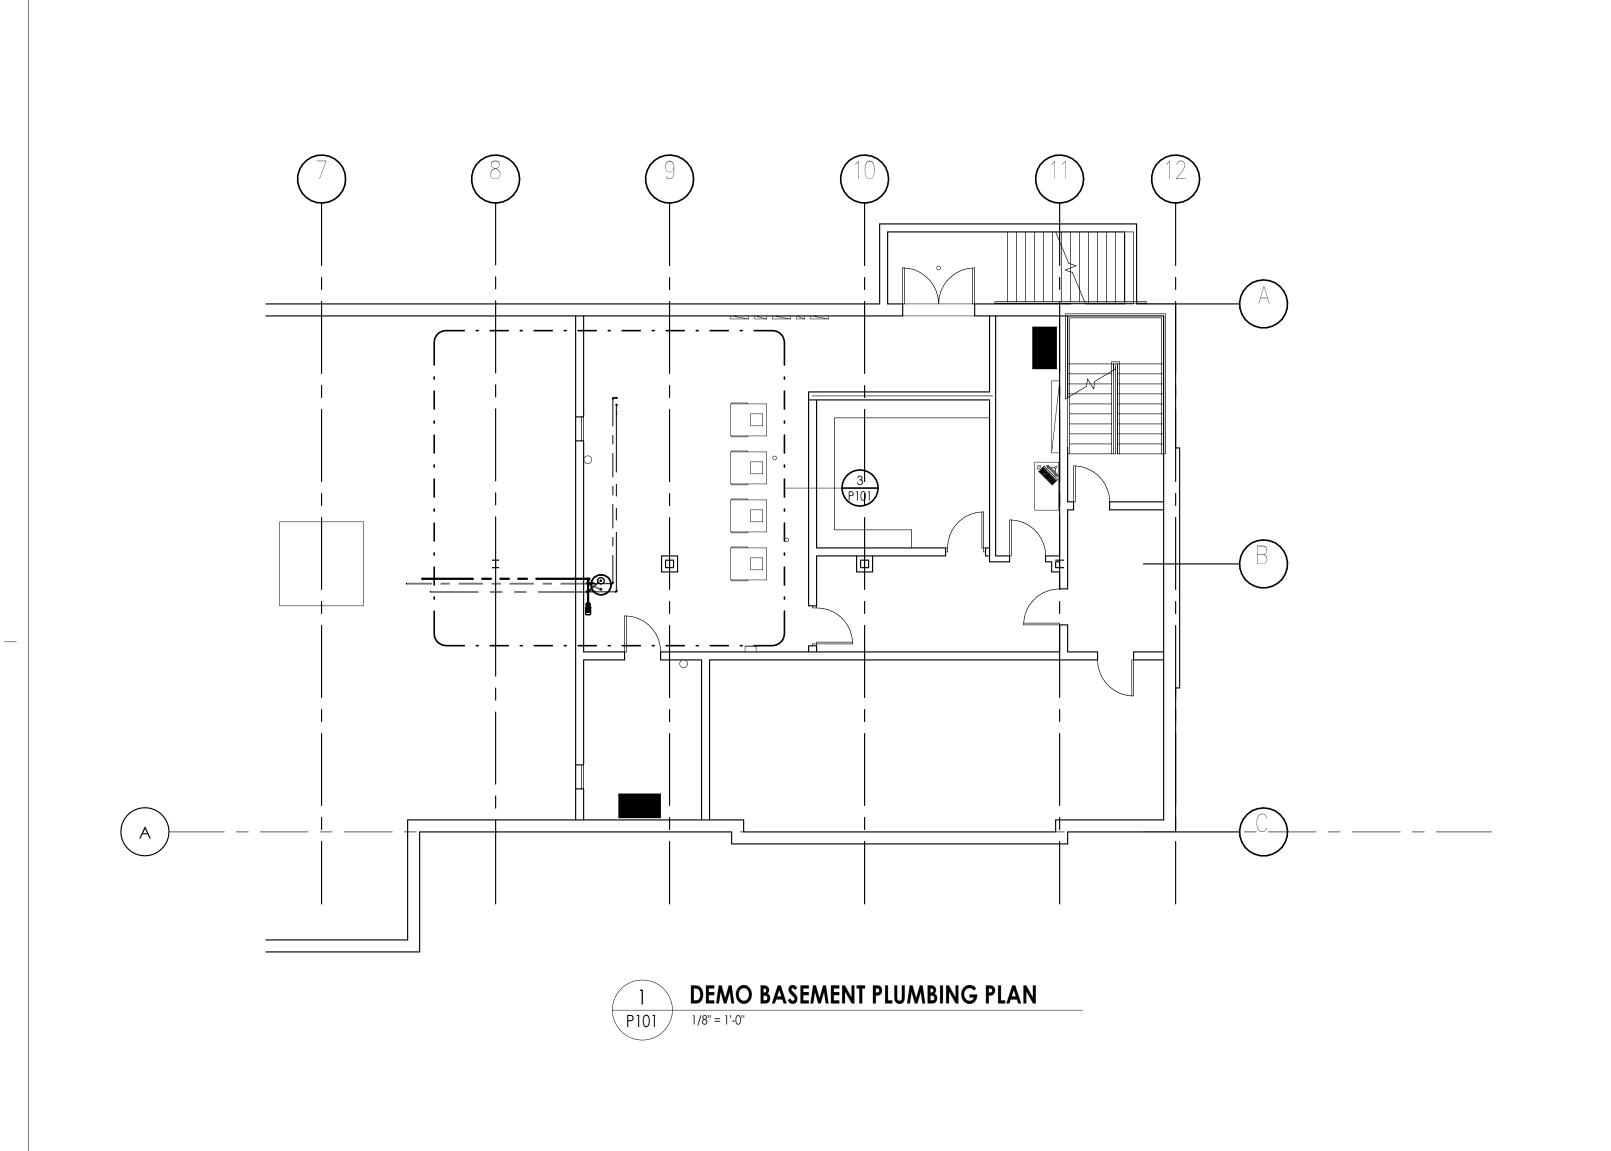

2 BASEMENT PLUMBING PLAN
P101 1/8" = 1'-0"

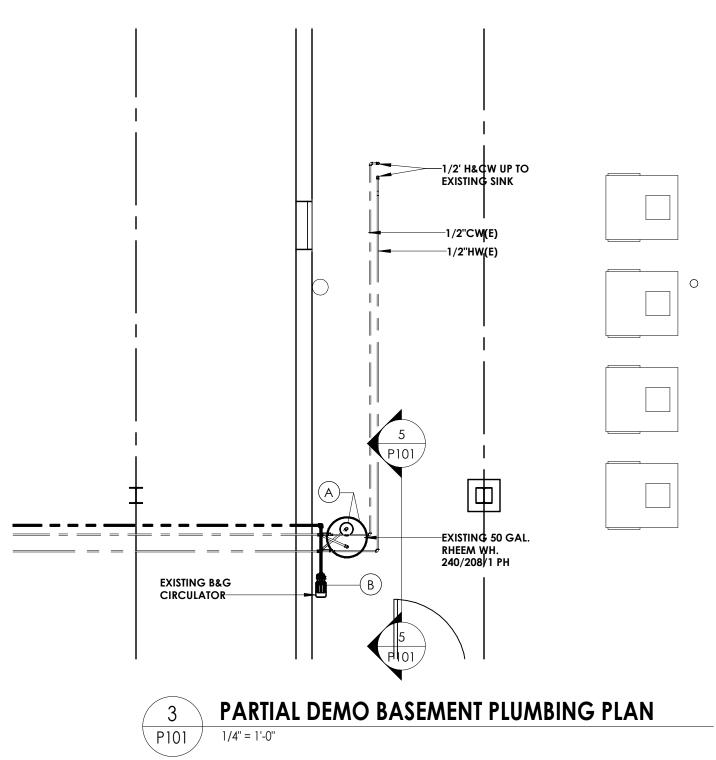

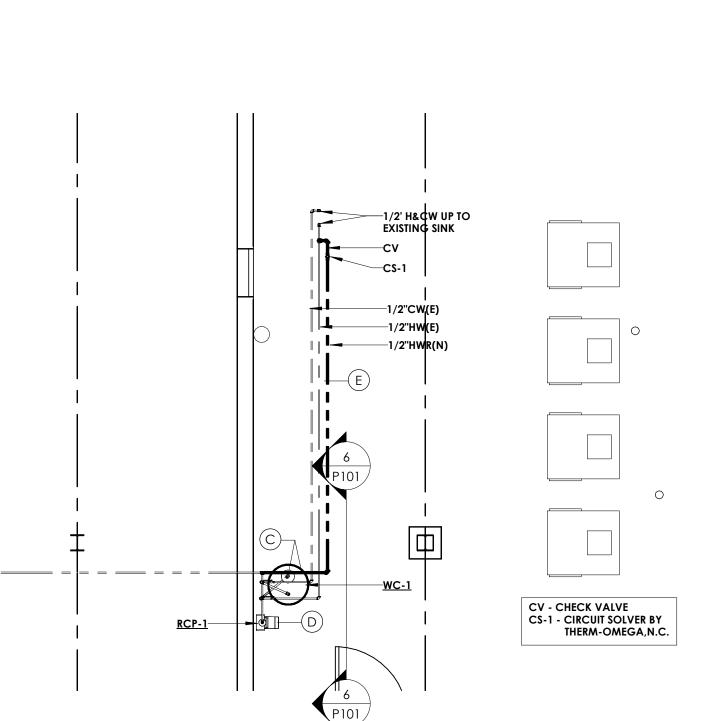



#### GENERAL NOTES

- A. REMOVE EXISTING 50 GALLON WATER HEATER AND EXPANSION TANK.
- B. REMOVE EXISTING RECIRC PUMP.
- C. INSTALL NEW 50 GALLON WATER HEATER AND EXPANSION TANK.
- D. INSTALL NEW RECIRC PUMP.
- E. INSTALL NEW RECIRC WATER LINE.



NC ENGINEERING FIRM LICENSE NO. C-2194

PROJECT INFORMATION

Project Number

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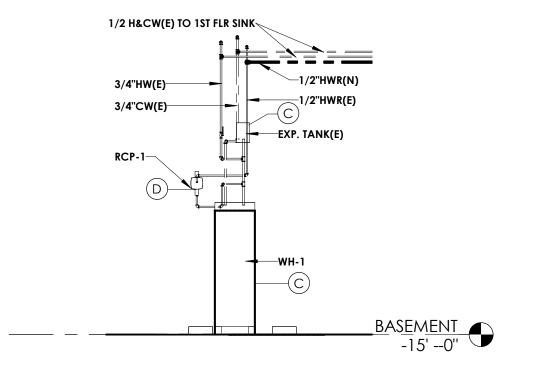
PLANNING BUILDING

RENOVATION

Project Address 18 LIBERTY STREET, YORK, SC

PROJECT ISSUE & REVISION SCHEDULE

# Date Description
1 5/16/2024 PLAN REVIEW COMMENTS



BASEMENT

**EXISTING WATER HEATER SECTION** 

1/2 H&CW(E) TO 1ST FLR SINK

3/4"HW(E) -

3/4"CW(E)-


6 NEW WATER HEATER SECTION
1/4" = 1'-0"

RECIRC PUMP SCHEDULE									
MARK	MANUFACTURER	MODEL NO.	GPM	HEAD(FT.)	WATTS	VOLTS	НР	CONNECTION	REMARKS
RCP-1	BELL & GOSSETT	ECOCIRC 20-18	5	10.4	22.4	120/1/60	0.03	3/4"U/3/4" SW	LOCATED AT WATER HEATER

ELECTRI	ELECTRIC WATER HEATER SCHEDULE								
MARK	MANUFACTURER	MODEL	TYPE	CAPACITY	RECOVERY	VOLTS/PH	kW	REMARKS	
WH-1	AO SMITH	DRE-52-12	ELECTRIC	50 GAL	50 GPH @ 100°F RISE	208V/3Ø	12	LOCATED IN BASEMENT MECHANICAL ROOM	

NOTES FOR WH-1:

1) PLUMBING CONTRACTOR TO SELECT AND INSTALL EXPANSION TANK PER WATER HEATER MANUFACTURER'S RECOMMENDATION.

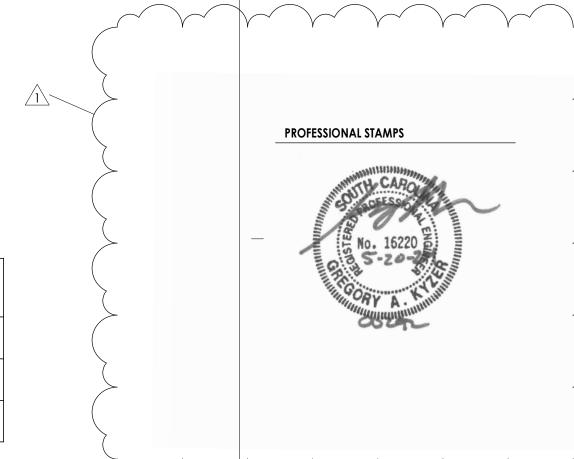

SHEET INFORMATION

Issued Scale

04/16/2023 As indicated

Project Status

100% CONSTRUCTION DOCUMENTS

Drawn By Checked By

Drawing Tifle
BASEMENT DEMOLITION AND
NEW WORK PLAN

Drawing Number

P101